

# GRANT AVENUE BRIDGE REHABILITATION CALTRANS BRIDGE NO. 27C0021 CIP PROJECT 09-003 FEDERAL AID PROJECT NO. BHLS 5361 (023)

CITY OF NOVATO

MARIN COUNTY

CALIFORNIA

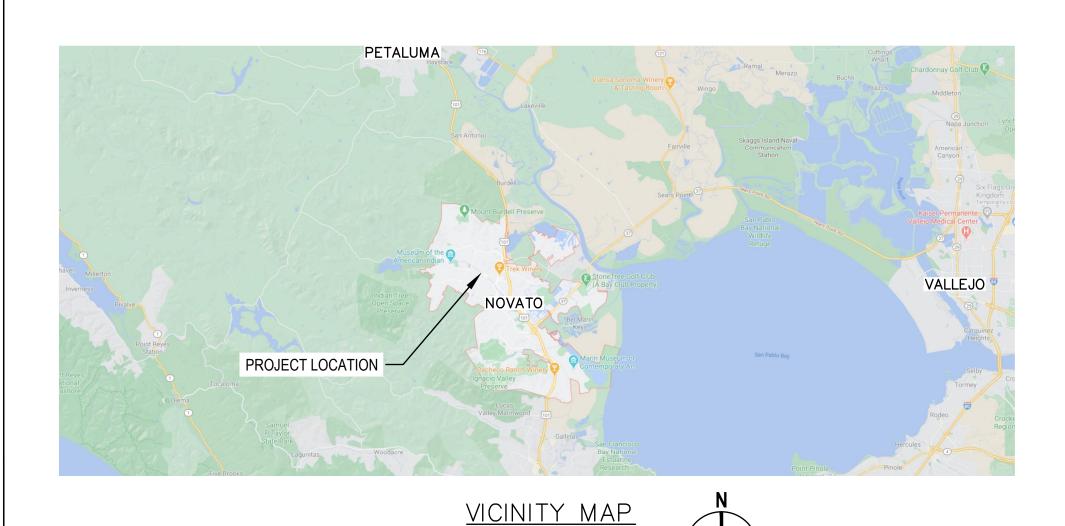

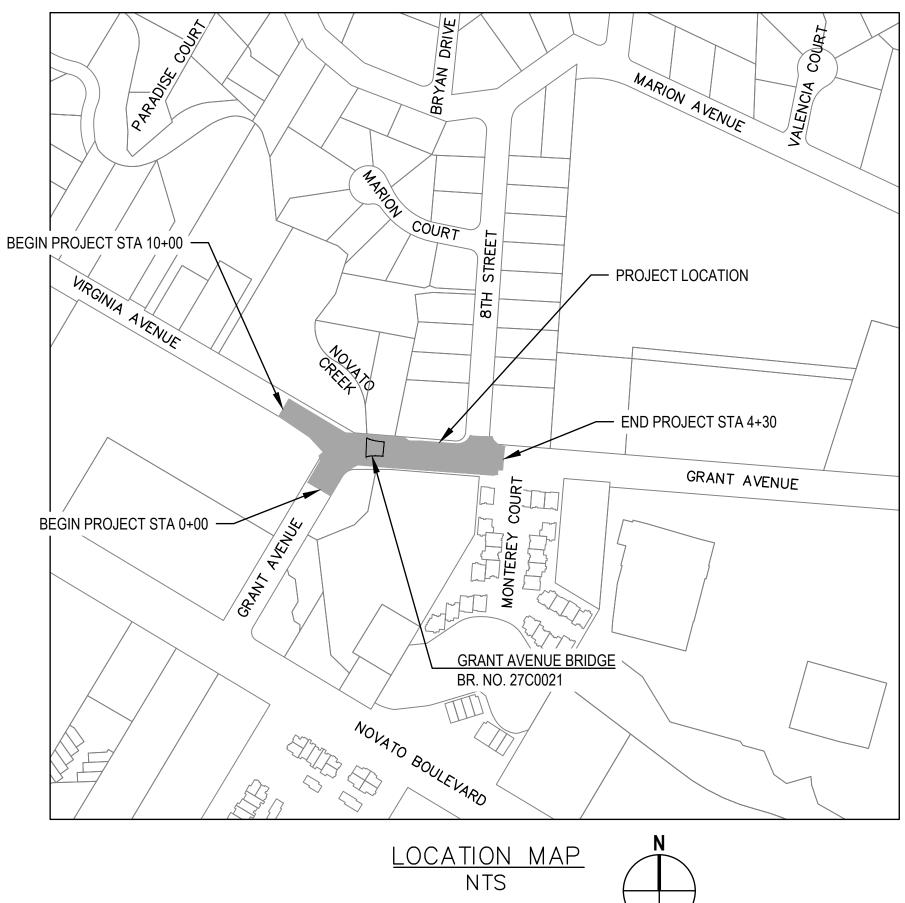

# SHEET INDEX


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1	RFA FOR CONSTRUCTION				9/28/2021	Reuse of Documents This document and the ideas and designs incorporated herein, as	s an instrument of		
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						Submitted By -	2/21/2023	. (	
						Project Engineer Project Engineer	Date	<b>\</b>	
						Approved By - Chin Ostabuelo 1/11	1/2024		
No	Revision Note: * indicates signatures on original issue of drawing or last revision of drawing	Drawn	Job Manager	Project Director	Date	City Engineer	Date		

Cad File No:

Plot Date:

Plotted by:



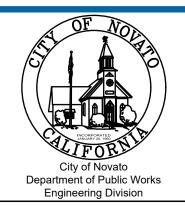



Drawn	Designer	
Drafting Check	Design Check	
Approved (City Engineer)	Submitted (Project Engineer)	
Date	Date	
	This Drawing shall not be used	1

Client	CITY OF NOVATO
	<b>GRANT AVENUE BRIDGE REHABILITATION (CIP 09-003)</b>
Title	TITLE SHEET

Contract No. 11110085

for Construction unless Signed Drawin

and Sealed For Construction

ze	T.4	Sht	1	of	47
ng No:	11		<b>R L</b>	v:	

#### GENERAL NOTES

- 1. THE CONTRACTOR SHALL INSPECT THE PROJECT SITE PRIOR TO SUBMITTING A BID IN ORDER TO OBSERVE AND DETERMINE THE EXISTING JOBSITE CONDITIONS.
- 2. THE CONTRACTOR SHALL HOLD HARMLESS THE CITY, THEIR AUTHORIZED REPRESENTATIVES FROM ALL LIABILITIES AND DAMAGES RESULTING FROM HIS CONSTRUCTION ACTIVITIES.
- THE CONTRACTOR AGREES THAT IN ACCORDANCE WITH GENERALLY ACCEPTED CONSTRUCTION PRACTICES, CONTRACTOR SHALL BE REQUIRED TO ASSUME COMPLETE RESPONSIBILITY FOR JOBSITE CONDITIONS DURING THE COURSE OF CONSTRUCTION OF THE PROJECT. THESE PLANS DO NOT INCLUDE COMPONENTS NECESSARY FOR CONSTRUCTION SAFETY. IT IS THE CONTRACTOR'S RESPONSIBILITY TO PROVIDE FOR THE SAFETY OF ALL PERSONS AND PROPERTY DURING THE COURSE OF THE PROJECT.
- 4. THE CONTRACTOR SHALL COMPLY WITH THE RULES AND REGULATIONS OF THE CAL/OSHA CONSTRUCTION SAFETY ORDERS. THIS REQUIREMENT SHALL BE MADE TO APPLY CONTINUOUSLY AND NOT BE LIMITED TO NORMAL WORKING HOURS.
- 5. IT IS THE CONTRACTOR'S RESPONSIBILITY TO VERIFY THE LOCATION AND ELEVATION OF ALL EXISTING UTILITIES INCLUDING ALL OVERHEAD AND BURIED UTILITIES WITHIN THE WORK AREA PRIOR TO BEGINNING CONSTRUCTION. CONTRACTOR SHALL PROCEED WITH CAUTION DURING UNDERGROUND OPERATIONS AND SHALL BE RESPONSIBLE FOR THE REPAIR OR REPLACEMENT OF ALL UTILITIES DAMAGED DURING CONSTRUCTION AT THE CONTRACTOR'S EXPENSE. CONTRACTOR SHALL NOTIFY UNDERGROUND SERVICE ALERT NORTH (U.S.A) AT 811 OR ONLINE AT WWW.USANORTH811.ORG A MINIMUM OF 48 HOURS IN ADVANCE OF ANY EXCAVATION.
- 6. EVERY EFFORT HAS BEEN MADE TO SHOW THE LOCATION OF EXISTING UTILITIES AND OBSTRUCTIONS WHICH MAY INTERFERE WITH THE WORK. CONTRACTOR SHALL NOTIFY THE APPROPRIATE AGENCIES PRIOR TO STARTING ANY WORK WHICH MAY AFFECT THEIR FACILITIES & IS FULLY RESPONSIBLE FOR ANY POTHOLING REQUIREMENTS. POTHOLING SHALL NOT BE MEASURED FOR PAYMENT, BUT SHALL BE CONSIDERED INCLUDED IN THE COST OF WORK FOR WHICH THE POTHOLING IS PERFORMED.
- 7. TRAFFIC CONTROL DURING CONSTRUCTION SHALL BE THE CONTRACTOR'S RESPONSIBILITY. ALL TRAFFIC CONTROL AND DEVICES SHALL BE IN ACCORDANCE WITH THE LATEST EDITION OF THE CALIFORNIA MANUAL ON UNIFORM TRAFFIC CONTROL DEVICES FOR STREETS AND HIGHWAYS.
- 8. THE CONTRACTOR SHALL PROVIDE FOR CONTINUOUS INGRESS AND EGRESS TO ALL PRIVATE PROPERTY ADJACENT TO THE WORK THROUGHOUT THE PERIOD OF CONSTRUCTION UNLESS OTHERWISE SHOWN.
- 9. THE CONTRACTOR SHALL BE RESPONSIBLE FOR ANY DAMAGES TO THE SITE OR THE SURROUNDING AREA AS A RESULT OF THE CONTRACTOR'S WORK OR OPERATIONS. EXISTING FACILITIES THAT ARE DAMAGED OR DISPLACED BY THE CONTRACTOR SHALL BE REPLACED AT THE CONTRACTOR'S EXPENSE.
- 10. ALL EXISTING FACILITIES, STRUCTURES, TREES, FENCES, LANDSCAPING, ETC. ARE TO REMAIN. ONLY THOSE SPECIFICALLY DESIGNATED FOR REMOVAL AS SHOWN ON THE PLANS, OR AS DIRECTED BY THE ENGINEER, SHALL BE REMOVED.
- 11. IF, DURING THE COURSE OF THE WORK, THE CONTRACTOR ENCOUNTERS ANY SURFACE OR SUBSURFACE MATERIALS THAT HE/SHE BELIEVES ARE HAZARDOUS (AS DEFINED IN SECTION 25117 OF THE HEALTH AND SAFETY CODE), THE CONTRACTOR MUST INFORM THE ENGINEER IN WRITING IMMEDIATELY. MATERIAL IS TO REMAIN UNDISTURBED UNTIL AN INVESTIGATION BY THE CITY. REMOVAL AND/OR DISPOSAL OF HAZARDOUS MATERIAL IS NOT PART OF THE SCOPE OF WORK.
- 12. THE CONTRACTOR SHALL CONTACT THE NORTH MARIN WATER DISTRICT AND NOVATO SANITARY DISTRICT 48 HOURS PRIOR TO GRINDING, PAVING AND GRADING. WHERE APPLICABLE, SEE CONTRACT SPECIFICATIONS FOR ADDITIONAL REQUIREMENTS.
- 13. ALL DIMENSIONS ARE FEET UNLESS OTHERWISE NOTED.

#### **ABBREVIATIONS**

ø	DIAMETER
AC	ASPHALT CONCRETE
AB	AGGREGATE BASE, ASPHALT BASE
AP	
	ANGLE POINT
APN	ASSESSOR'S PARCEL NUMBER
32B	BACK TO BACK
3C	BEGIN CURVE
BEG	BEGINNING
3R	BRIDGE
3SW	BACK OF SIDEWALK
BVCS	BEGINNING VERTICAL CURVE STATION
C	CONDUIT
(CA)	CALIFORNIA
ĊL .	CENTERLINE
CL2	CLASS 2
CLR	CLEAR
OI .	DROP INLET
OWA	DRIVEWAY APPROACH
OWY	DRIVEWAY
ΞC	END CURVE
ΞG	EXISTING GROUND
	ELEVATION
, 	EDGE OF PAVEMENT
EVCS	END VERTICAL CURVE STATION
(E)	EXISTING
-C	FACE OF CURB
-L	FLOW LINE
-G	FINISHED GROUND
-H	FIRE HYDRANT
;; G	GAS
GB	GRADE BREAK
HORIZ	HORIZONTAL
HMA	HOT MIX ASPHALT
NV	INVERT
JP	JOINT POLE
_IP	LIP OF GUTTER
_''' _F	LINEAR FEET
_' _P	LOW POINT
_r MAX	MAXIMUM
MCUCS	
MIN	MINIMUM
MH	
MON	
MUTCD	
(N)	NEW/PROPOSED
NMWD	
NTS	NOT TO SCALE
OC .	ON CENTER
OHT	OVERHEAD TELEPHONE LINE
	OVERHEAD UTILITY LINE
PCC	PORTLAND CEMENT CONCRETE


PUBLIC UTILITY EASEMENT POINT OF VERTICAL INTERSECTION PVMT PAVEMENT RADIUS REINFORCED CONCRETE PIPE ROCK SLOPE PROTECTION RETAINING WALL RIGHT OF WAY STORM DRAIN SANITARY SEWER SANITARY SEWER MANHOLE STATION STANDARD STD SIDEWALK TOP OF CURB **TEMPORARY** TRAFFIC INDEX **TYPICAL** UNIFORM CONSTRUCTION STANDARDS UNLESS OTHERWISE NOTED UON VARIABLE VAR **VERTICAL** WATER WATER METER WATER VALVE WINGWALL WINGWALL LAYOUT LINE

#### CONSTRUCTION NOTES

- 1. ALL MINOR CONCRETE SHALL BE CLASS A (SIX SACK MIX).
- 2. NO CONCRETE SHALL BE PLACED PRIOR TO FORM INSPECTION AND STEEL APPROVAL BY THE CITY ENGINEER.
- 3. ALL CONCRETE SIDEWALKS, CURB AND GUTTERS, AND DRIVEWAYS SHALL BE BROOM FINISHED.
- 4. TOP CONCRETE SHALL BE CAST IN PLACE.
- ALL CONCRETE SIDEWALK CROSS SLOPES SHALL BE 1.5% UNLESS OTHERWISE NOTED.
- 6. TRENCH EXCAVATION AND BACKFILL SHALL BE IN ACCORDANCE WITH UCS DRAWING NO. 330, 340, 350
- 7. ALL ASPHALT CONFORMS SHALL BE SAWCUT UNLESS OTHERWISE NOTED.
- 8. THE CONTRACTOR SHALL CONTACT CITY OF NOVATO TRAFFIC ENGINEERING TO COORDINATE THE CAT TRACKING AND LAYOUT WORK INCLUDING EXACT LOCATIONS AND PLACEMENT. ALL CAT TRACKING AND LAYOUT ARE TO BE IN PLACE AT LEAST 48 HOURS IN ADVANCE OF PLACING ANY PAVEMENT STRIPING, DELINEATION OR PAVEMENT MESSAGES TO ALLOW TIME FOR CITY TO REVIEW.
- 9. ALL STRIPING AND PAVEMENT MARKINGS IN THIS CONTRACT SHALL BE THERMOPLASTIC. NO THERMOPLASTIC MAY BE PLACED WITHIN FIVE DAYS OF PAVING.
- 10. THE CONTRACTOR IS RESPONSIBLE FOR MONUMENTING EXISTING STRIPING AND MARKINGS TO FACILITATE REPLACEMENT, WHERE NEW LAYOUT IS NOT SHOWN.
- 11. IT IS THE CONTRACTOR'S RESPONSIBILITY TO RE-ESTABLISH AND MAINTAIN TEMPORARY REFLECTIVE INDICATIONS FOR ALL TRAFFIC STRIPING REMOVED OR DEGRADED BY THE PROJECT AT THE END OF EACH WORKING DAY AND AS NEEDED BETWEEN WORKING DAYS.
- 12. QUANTITIES SHOWN FOR REMOVAL ARE BASED ON IN-SITU VALUES. QUANTITIES SHOWN FOR NEW IMPROVEMENTS ARE BASED ON NEATLINE VOLUMES, AREAS OR LENGTHS. CONTRACTOR SHALL ACCOUNT FOR SHRINKAGE OR BULKING FACTORS TO DETERMINE ACTUAL DISPOSAL OR MATERIAL QUANTITIES REQUIRED.
- 13. SIDEWALK, CURB AND GUTTER SHALL BE IN ACCORDANCE WITH THE LATEST EDITION OF UNIFORM CONSTRUCTION STANDARDS (UCS) FOR ALL CITIES AND COUNTY OF MARIN DRAWING NO. 105 AND SHALL COMPLY WITH CITY OF NOVATO DESIGN AND CONSTRUCTION STANDARDS (INTERIM), AS OUTLINED IN MEMORANDUM ISSUED SEPTEMBER 9, 2014 (UCS MODIFICATION-NOVATO PARAGRAPH NO. 2).
- 14. CONSTRUCT NEW PEDESTRIAN CURB RAMPS PER 2023 CALTRANS STANDARD PLAN A88A. PROVIDE DETECTABLE WARNING SURFACE PER CALTRANS STANDARD A88A. MAXIMUM RAMP SLOPE = 7.5%; MAXIMUM CROSS SLOPE = 1.5%; MAXIMUM SLOPE @ CURB (CASE A, TYP) = 9%.

EXISTING	
15	CONTROL POINT
<i>co</i>	SANITARY SEWER CLEANOUT
SS	SANITARY SEWER MANHOLE
	STORM DRAIN DROP INLET
W	WATER METER
	WATER VALVE
OJP OR OPP	UTILITY POLE
$\leftarrow$	GUY WIRE
	SIGN
$\odot$	TREE
	CENTER LINE
x	FENCE
они	OVERHEAD UTILITY LINE
₩	WATER
G	GAS
22 22	SANITARY SEWER
	RIGHT OF WAY (R/W) LINE
	PUBLIC UTILITY EASEMENT (PUE)
	ACCESS EASEMENT
TCE	TEMPORARY CONSTRUCTION EASEMENT (TCE)
STOP	PAVEMENT MARKING, PER STD. PLAN A24D (WHITE, UON)
XDIG	PAVEMENT MARKING, PER STD. PLAN A24D (WHITE, UON)
SCHOOL	PAVEMENT MARKING, PER STD. PLAN A24D (WHITE, UON)
	TYPE IV (R) ARROW, PER STD. PLAN A24A
1	TYPE IV (L) ARROW, PER STD. PLAN A24A
5 19	— DETAIL NUMBER — SHEET ON WHICH DETAIL IS SHOWN
<u>PROPOSED</u>	
xxx	FENCE
••••	BOLLARDS
i	PEDESTRIAN CURB RAMP
	SIDEWALK
	CURB AND GUTTER

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Drawn		Designer		Client	CITY	OF
Diawii	NT	Designer	JS	Project	GRA	
Drafting Check	JS	Design Check	BS	Title	GEN	IER.
Approved (City Engineer)		Submitted (Project Engineer)	JS		SYN	
Date		Date	12/21/23	Contract	No. 111	11008
Scale	N/A	This Drawing shall for Construction ur and Sealed For Co	nless Signed	Original Size  Drawin		<b>T2</b>

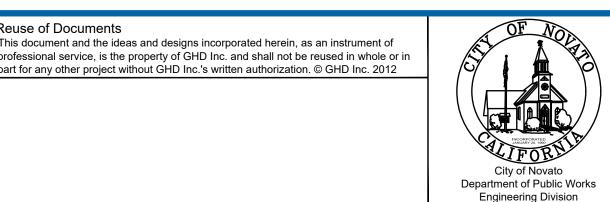and Sealed For Construction

lient CITY OF NOVATO Project GRANT AVENUE BRIDGE REHABILITATION (CIP 09-003) **GENERAL NOTES, ABBREVIATIONS, AND SYMBOLS** 

contract No. 11110085

Sht 2 of 47 Rev:


POINT OF INTERSECTION

POINT OF REVERSE CURVE

POWER POLE

PP

Plot Date: 28 September 2021

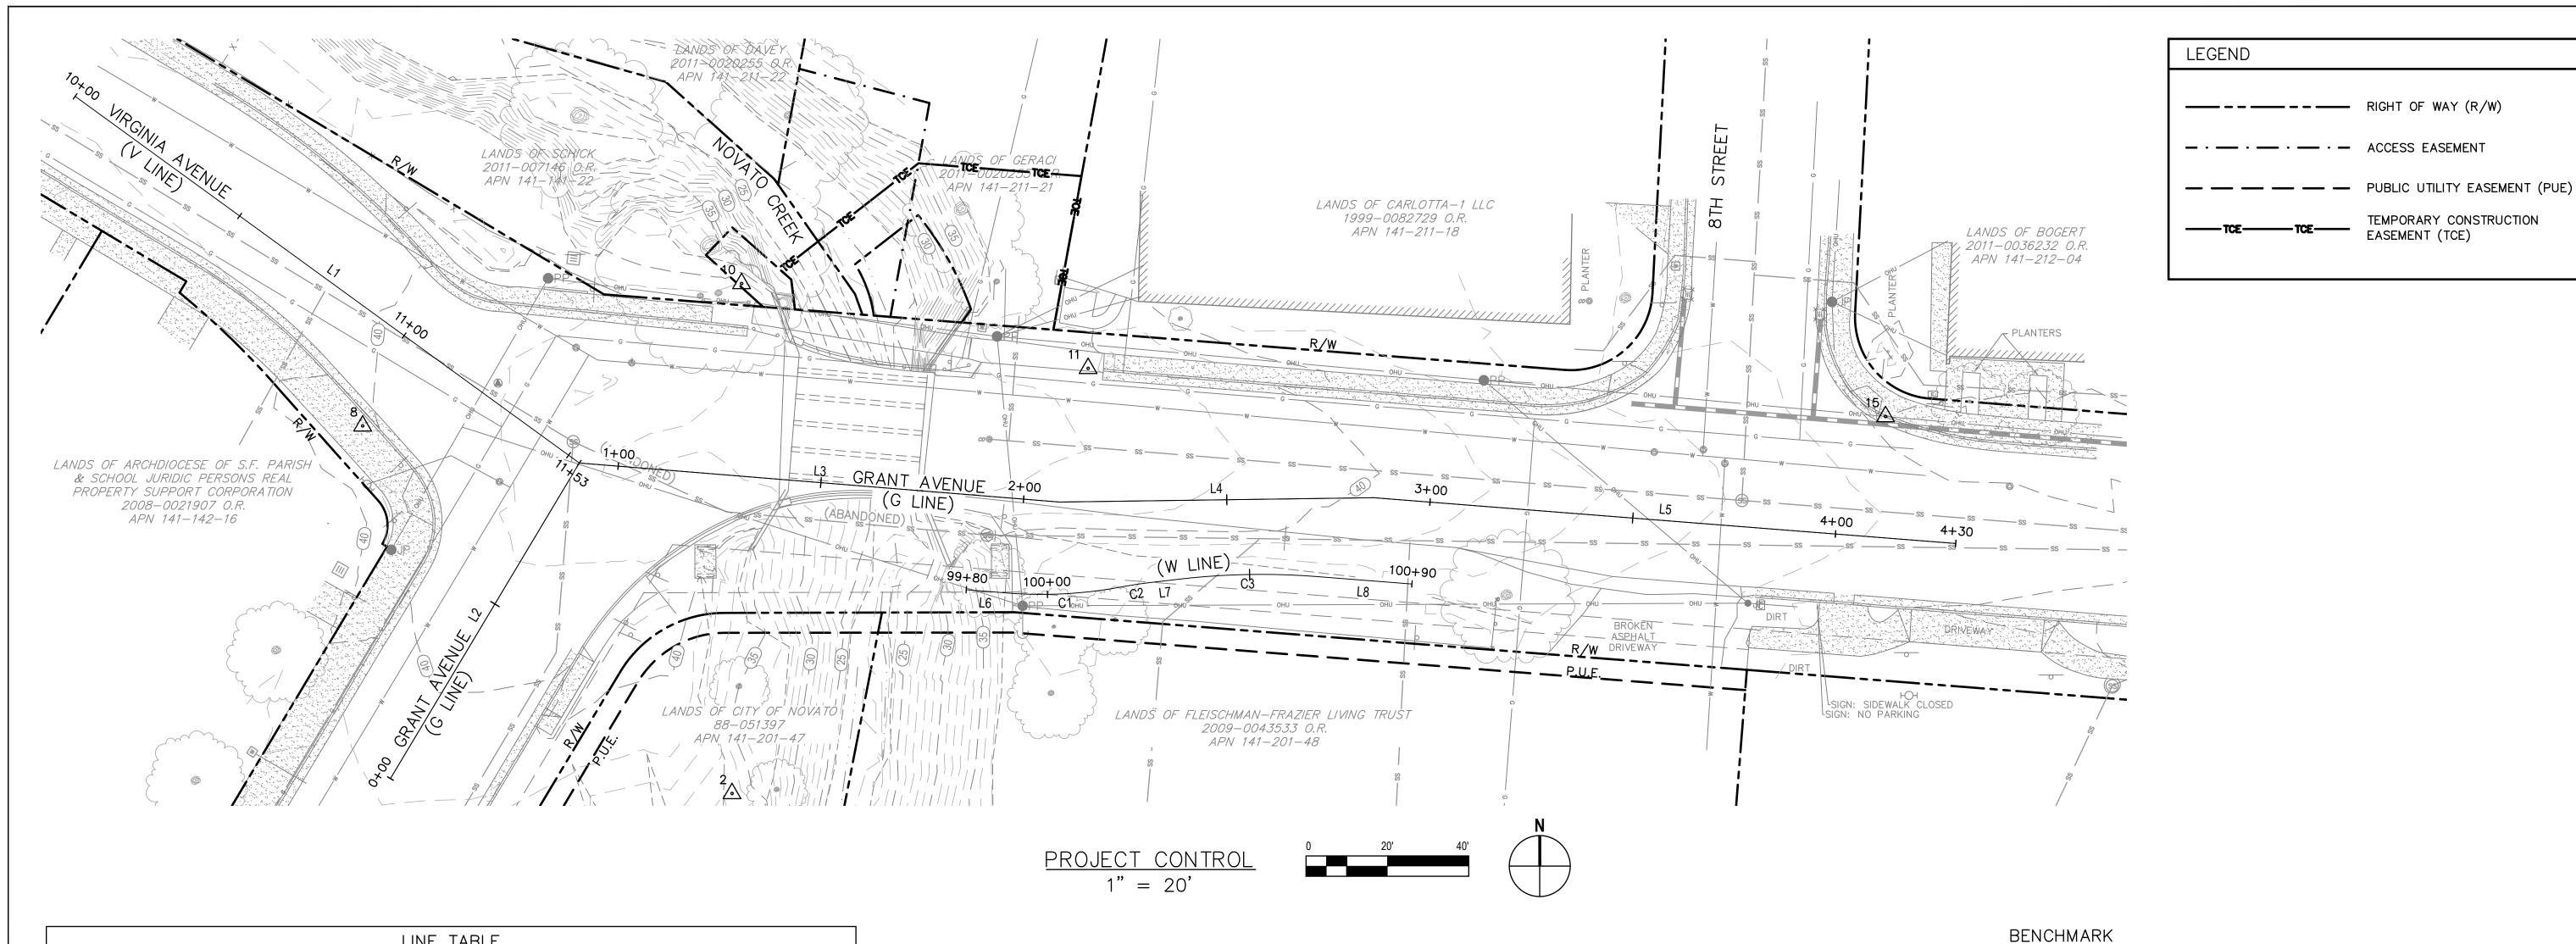

	LINE TABLE									
LINE	ALIGNMENT	LENGTH	BEARING	BEGIN STATION	END STATION	BEGIN STATION NORTHING	BEGIN STATION EASTING			
L1	V LINE	153.25	S53*58'33"E	10+00.00	11+53.25	2233167.0652	5962386.1862			
L2	G LINE	90.41	N30*53'50"E	0+00.00	0+90.41	2232999.3560	5962463.7087			
L3	G LINE	118.44	S85°20'57"E	0+90.41	2+08.85	2233076.9330	5962510.1327			
L4	G LINE	77.30	N89°12'45"E	2+08.85	2+86.15	2233067.3294	5962628.1817			
L5	G LINE	99.50	S85*30'23"E	2+86.15	3+85.65	2233068.3918	5962705.4770			

		SURVEY COM	NTROL DAT	A
NO.	NORTHING	EASTING	ELEVATION	DESCRIPTION
2	2232995.6710	5962547.6810	36.814	SPIKE
8	2233086.041	5962456.871	40.45	CUT 'X'
10	2233121.051	5962550.034	41.11	SPIKE
11	2233100.193	5962635.229	41.80	MAG NAIL
15	2233088.337	5962831.279	35.10	CUT 'X'

LINE TABLE: "W" LINE									
LINE	LENGTH	BEARING	BEGIN NORTHING	BEGIN EASTING					
L6	9.96	S85 <b>°</b> 20'57"E	2233045.7829	5962605.2702					
L7	7.18	N83°15'04"E	2233047.5058	5962650.2889					
L8	23.52	S85*30'23"E	2233049.0187	5962691.4034					

		CUR'	VE TABLE	E: "W" LINE	
CURVE	RADIUS	LENGTH	DELTA	BEGIN NORTHING	BEGIN EASTING
C1	106.00	28.26	15"16'32"	2233044.9753	5962615.1975
C2	104.00	7.04	3 <b>°</b> 52'33"	2233046.4435	5962643.3359
C3	173.50	34.04	11°14'32"	2233048.3498	5962657.4213


CONTROL POINT #8 - A CUT 'X' IN CONCRETE, AT THE SOUTHWEST CORNER OF GRANT AVENUE AND VIRGINIA AVENUE ELEVATION: 40.45 FEET. (NAVD88)


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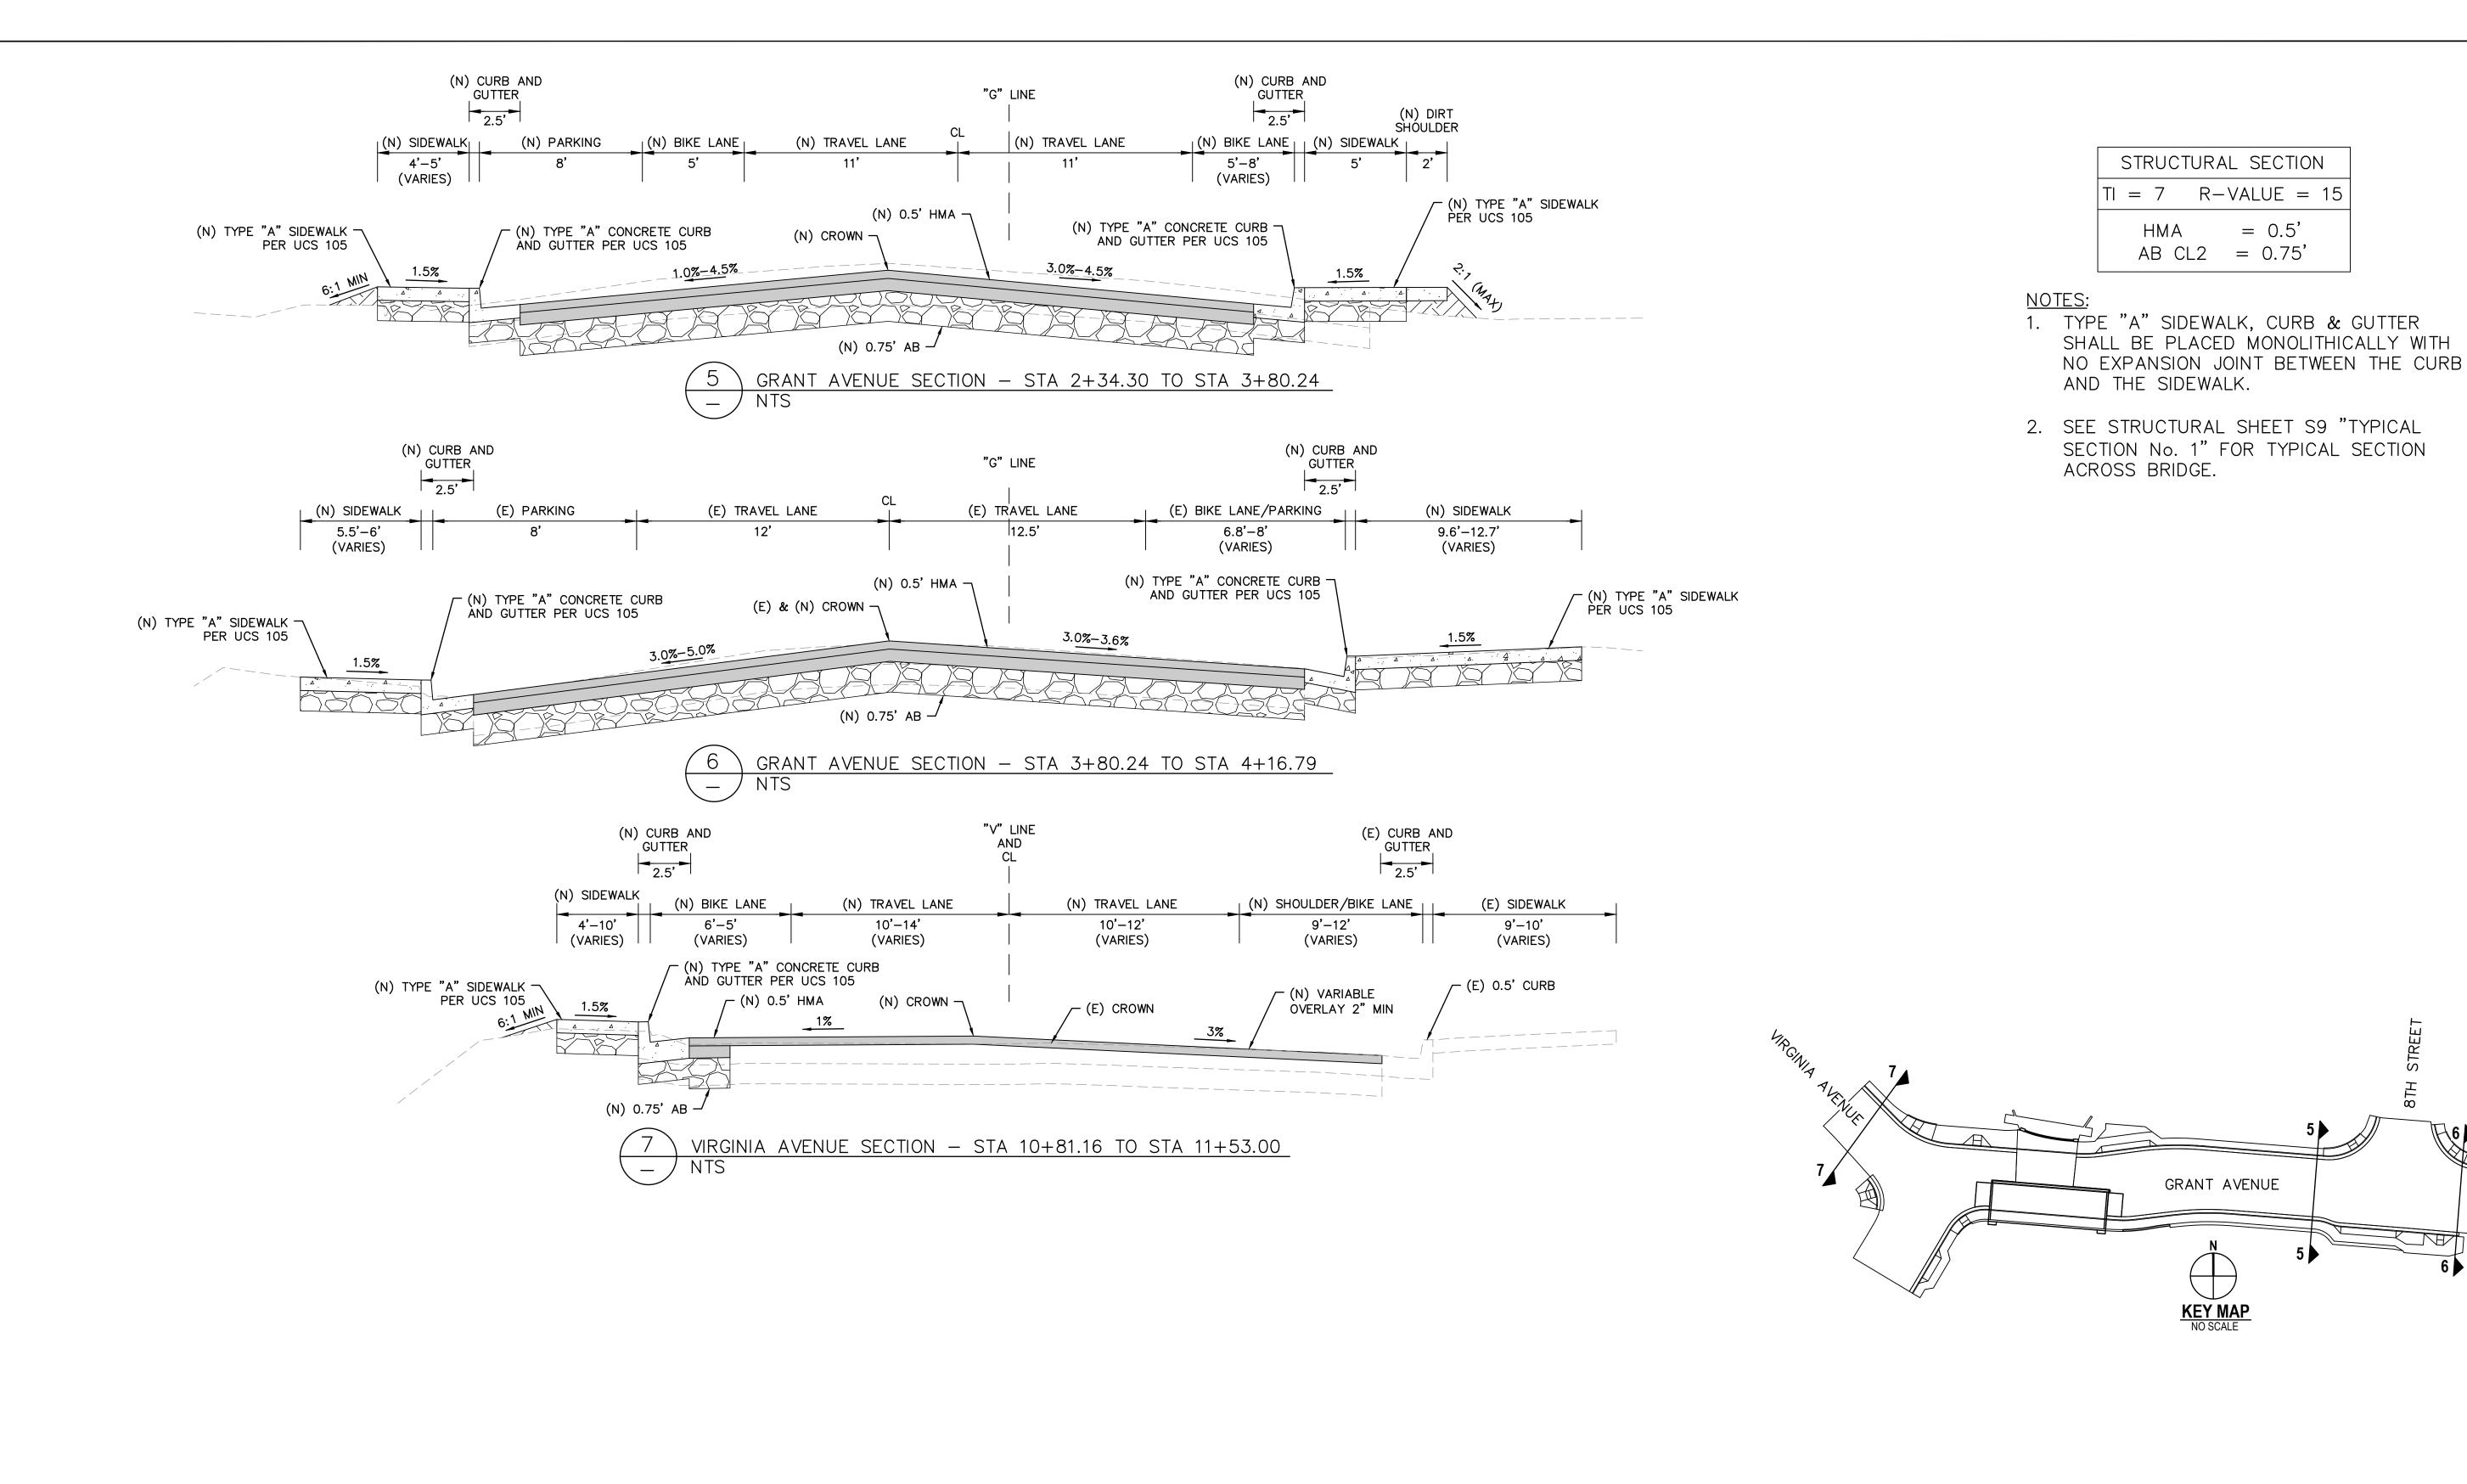
THE BASIS OF BEARINGS FOR THIS SURVEY IS THE CALIFORNIA

COORDINATE SYSTEM, ZONE II, NAD 83.

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	City of Novato	GHD Inc. 2235 Mercury Way Suite 150 Santa Rosa California 95407 USA  Check  Approve (City English) Date	JS Check BS  ed Submitted JS  (Project Engineer)  Date 12/21	Title PROJECT CONTROL  Contract No. 11110085
No Revision Note: * indicates signatures on original issue of drawing or last revision of drawing Drawn Job Manager Director Date	City of Novato Department of Public Works Engineering Division	2235 Mercury Way Suite 150 Santa Rosa California 95407 USA  T 1 707 523 1010 F 1 707 527 8679  W www.ghd.com  Scale	This Drawing shall not be for Construction unless Si and Sealed For Construct	Original Size Drawing No: PC1  Rev:




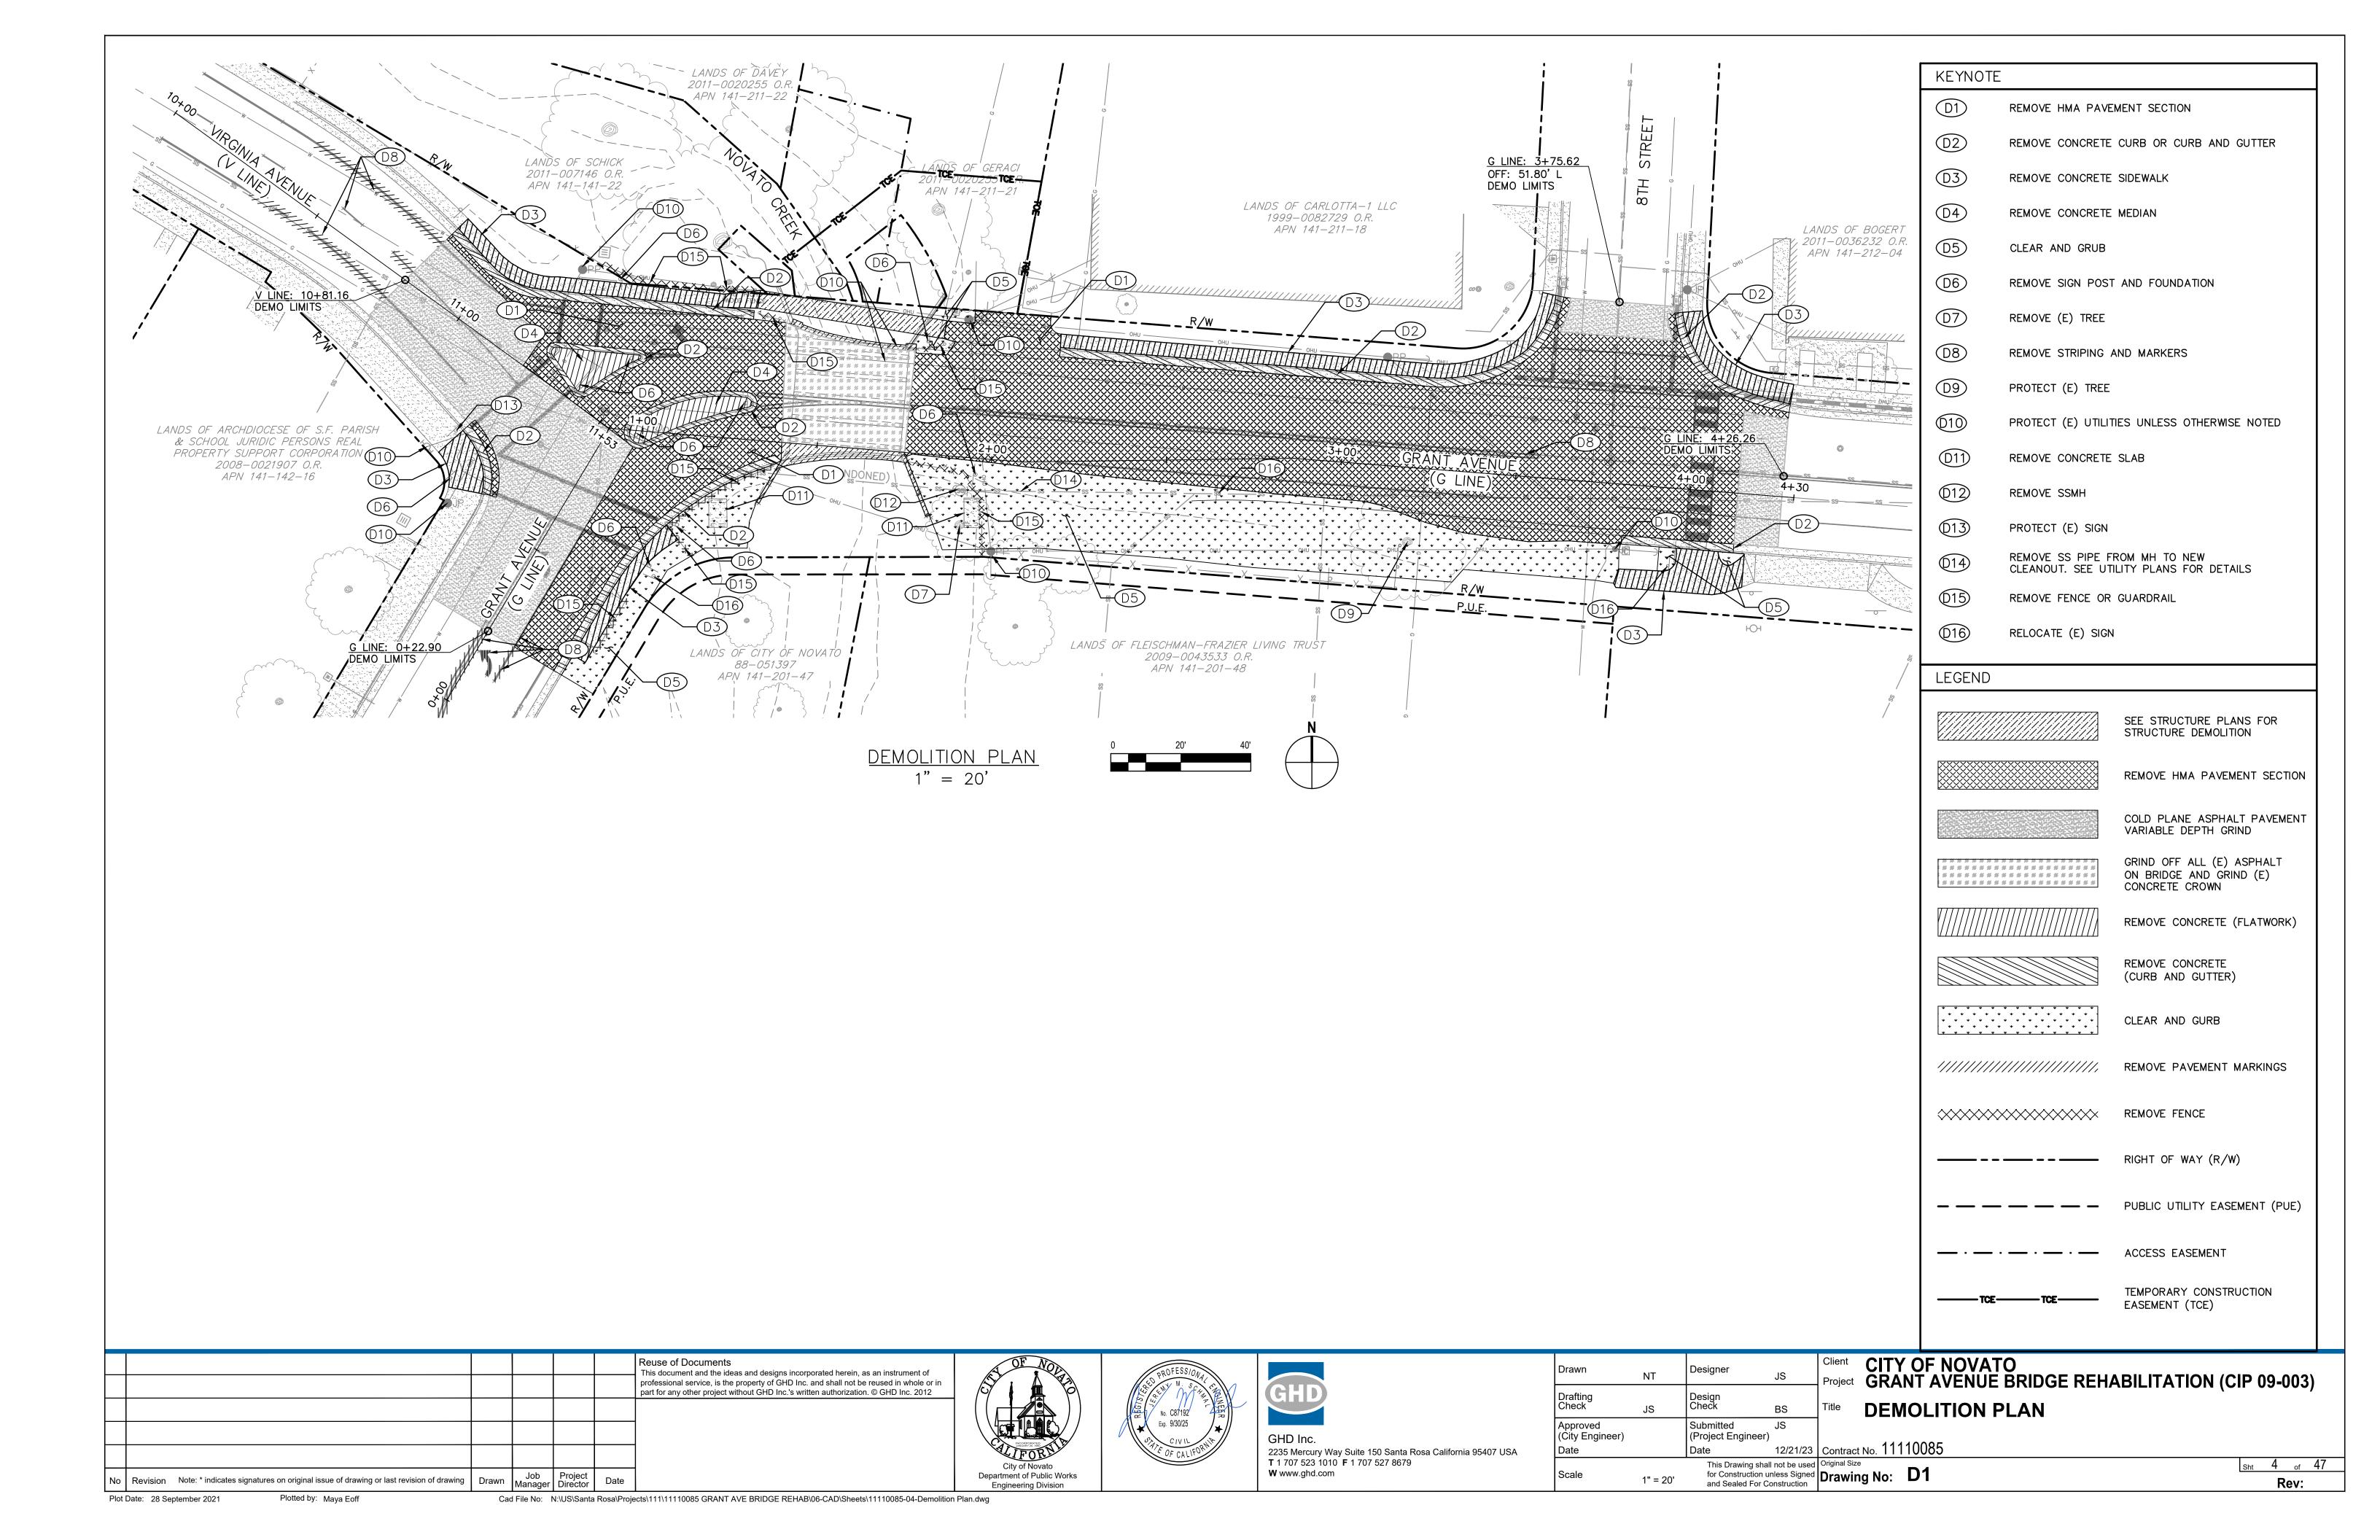


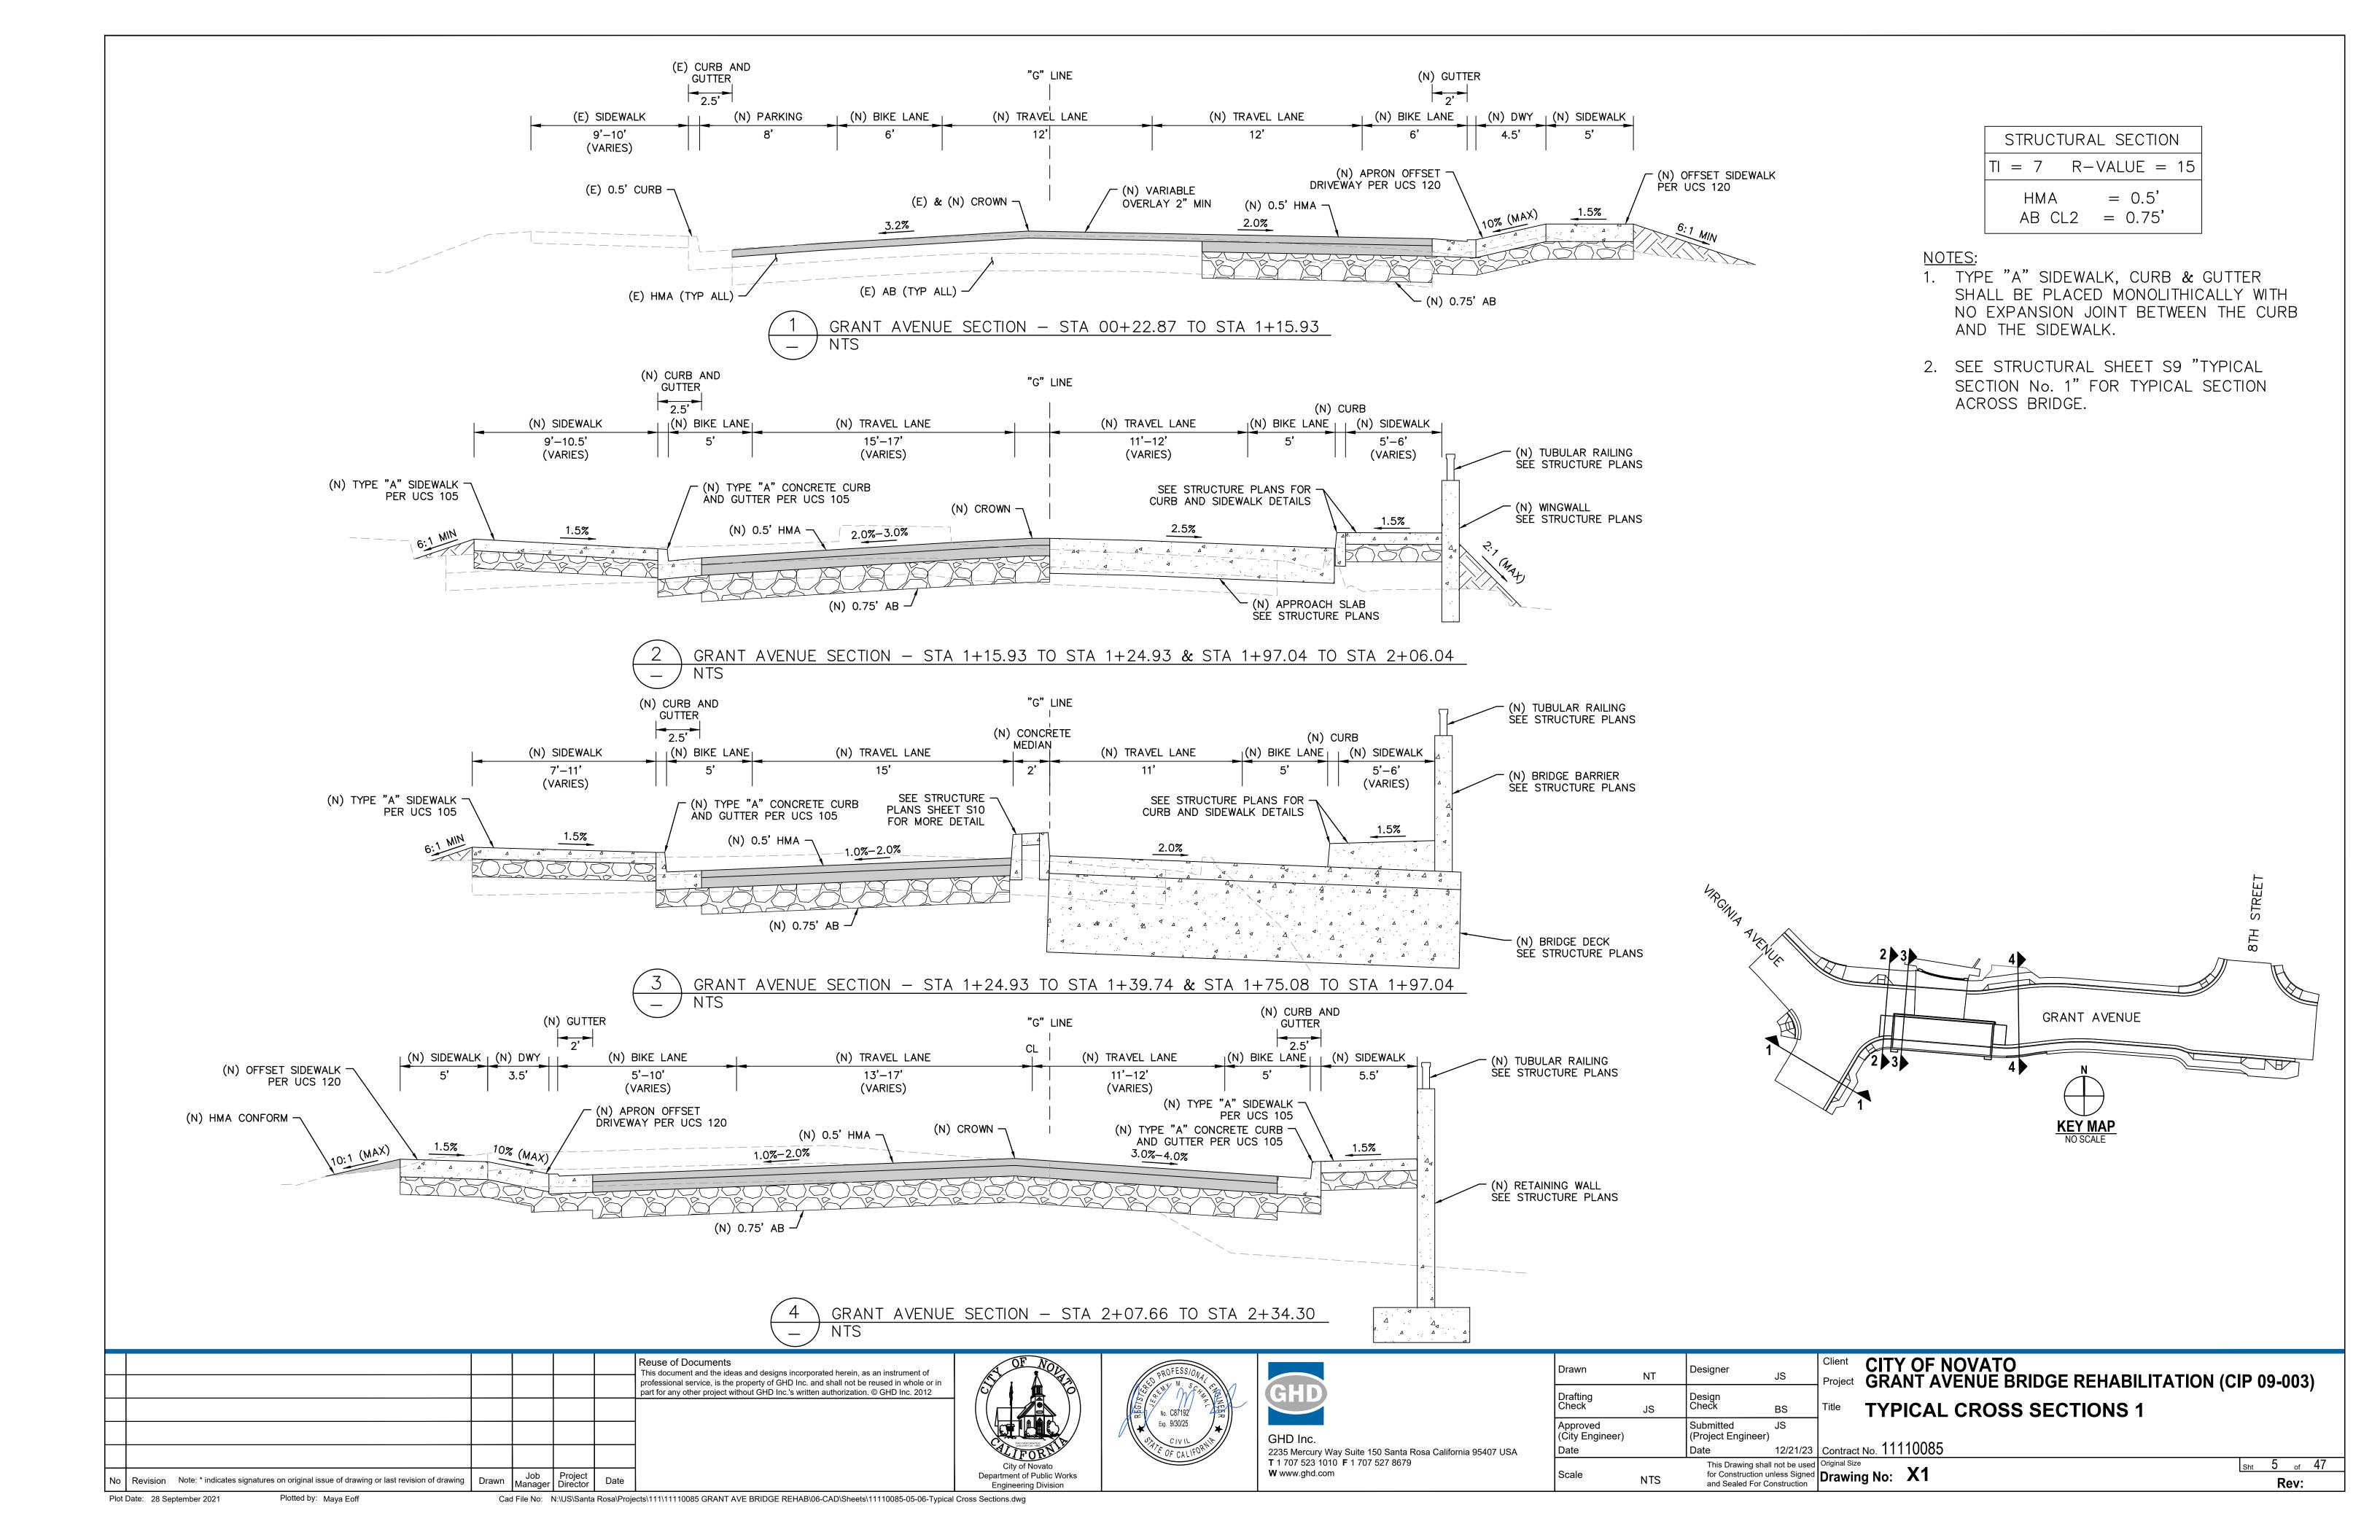



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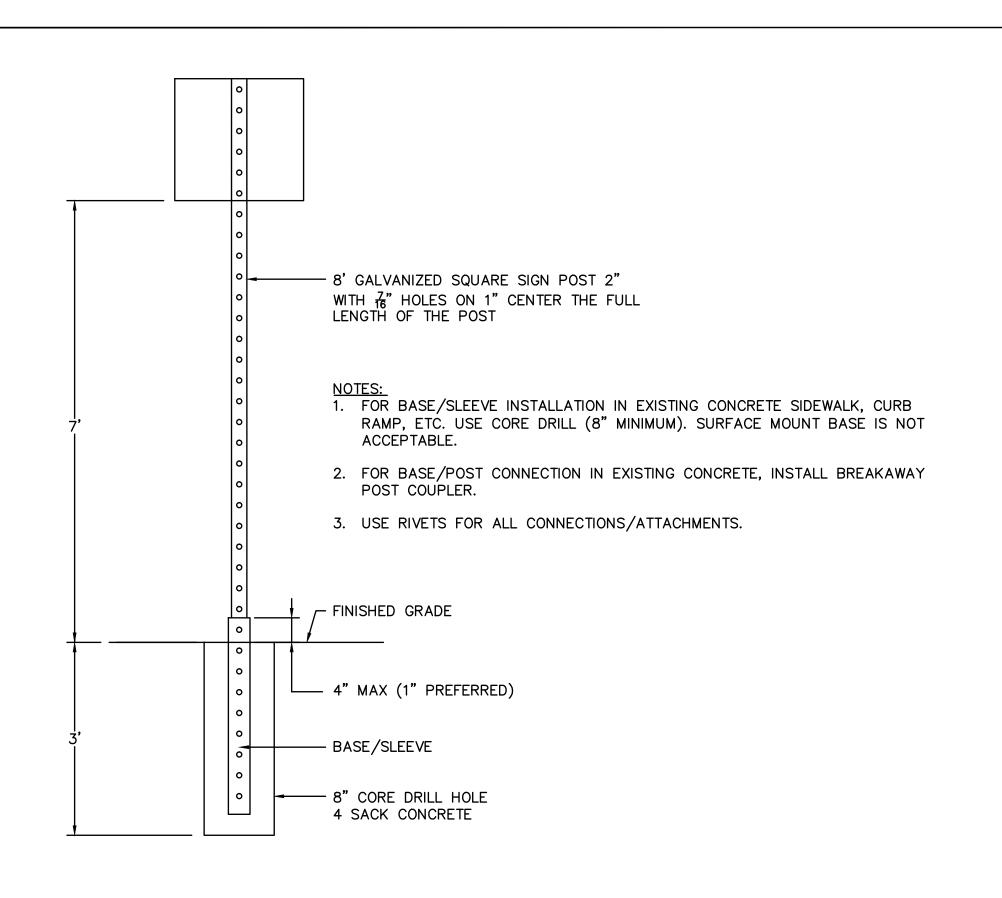
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	part for any other project without GHD Inc.'s written authorization. © GHD Inc. 2012		No. C87192 Exp. 9/30/25	GHD	Drafting Check Approved	JS	Design Check Submitted		PICAL CROSS SECTIONS 2	,
No. Povicion Note: * indicates signatures on original issue of drawing or last revision of drawing. Drawn Job Project Do	to l	City of Novato Department of Public Works	CIVIL OF CALIFORNIA	GHD Inc. 2235 Mercury Way Suite 150 Santa Rosa California 95407 USA T 1 707 523 1010 F 1 707 527 8679 W www.ghd.com	(City Engineer) Date Scale	NTS	(Project Engire Date  This Drawing for Construction	12/21/23 Contract No. 1	1110085 : <b>X2</b>	Sht 6 of 47



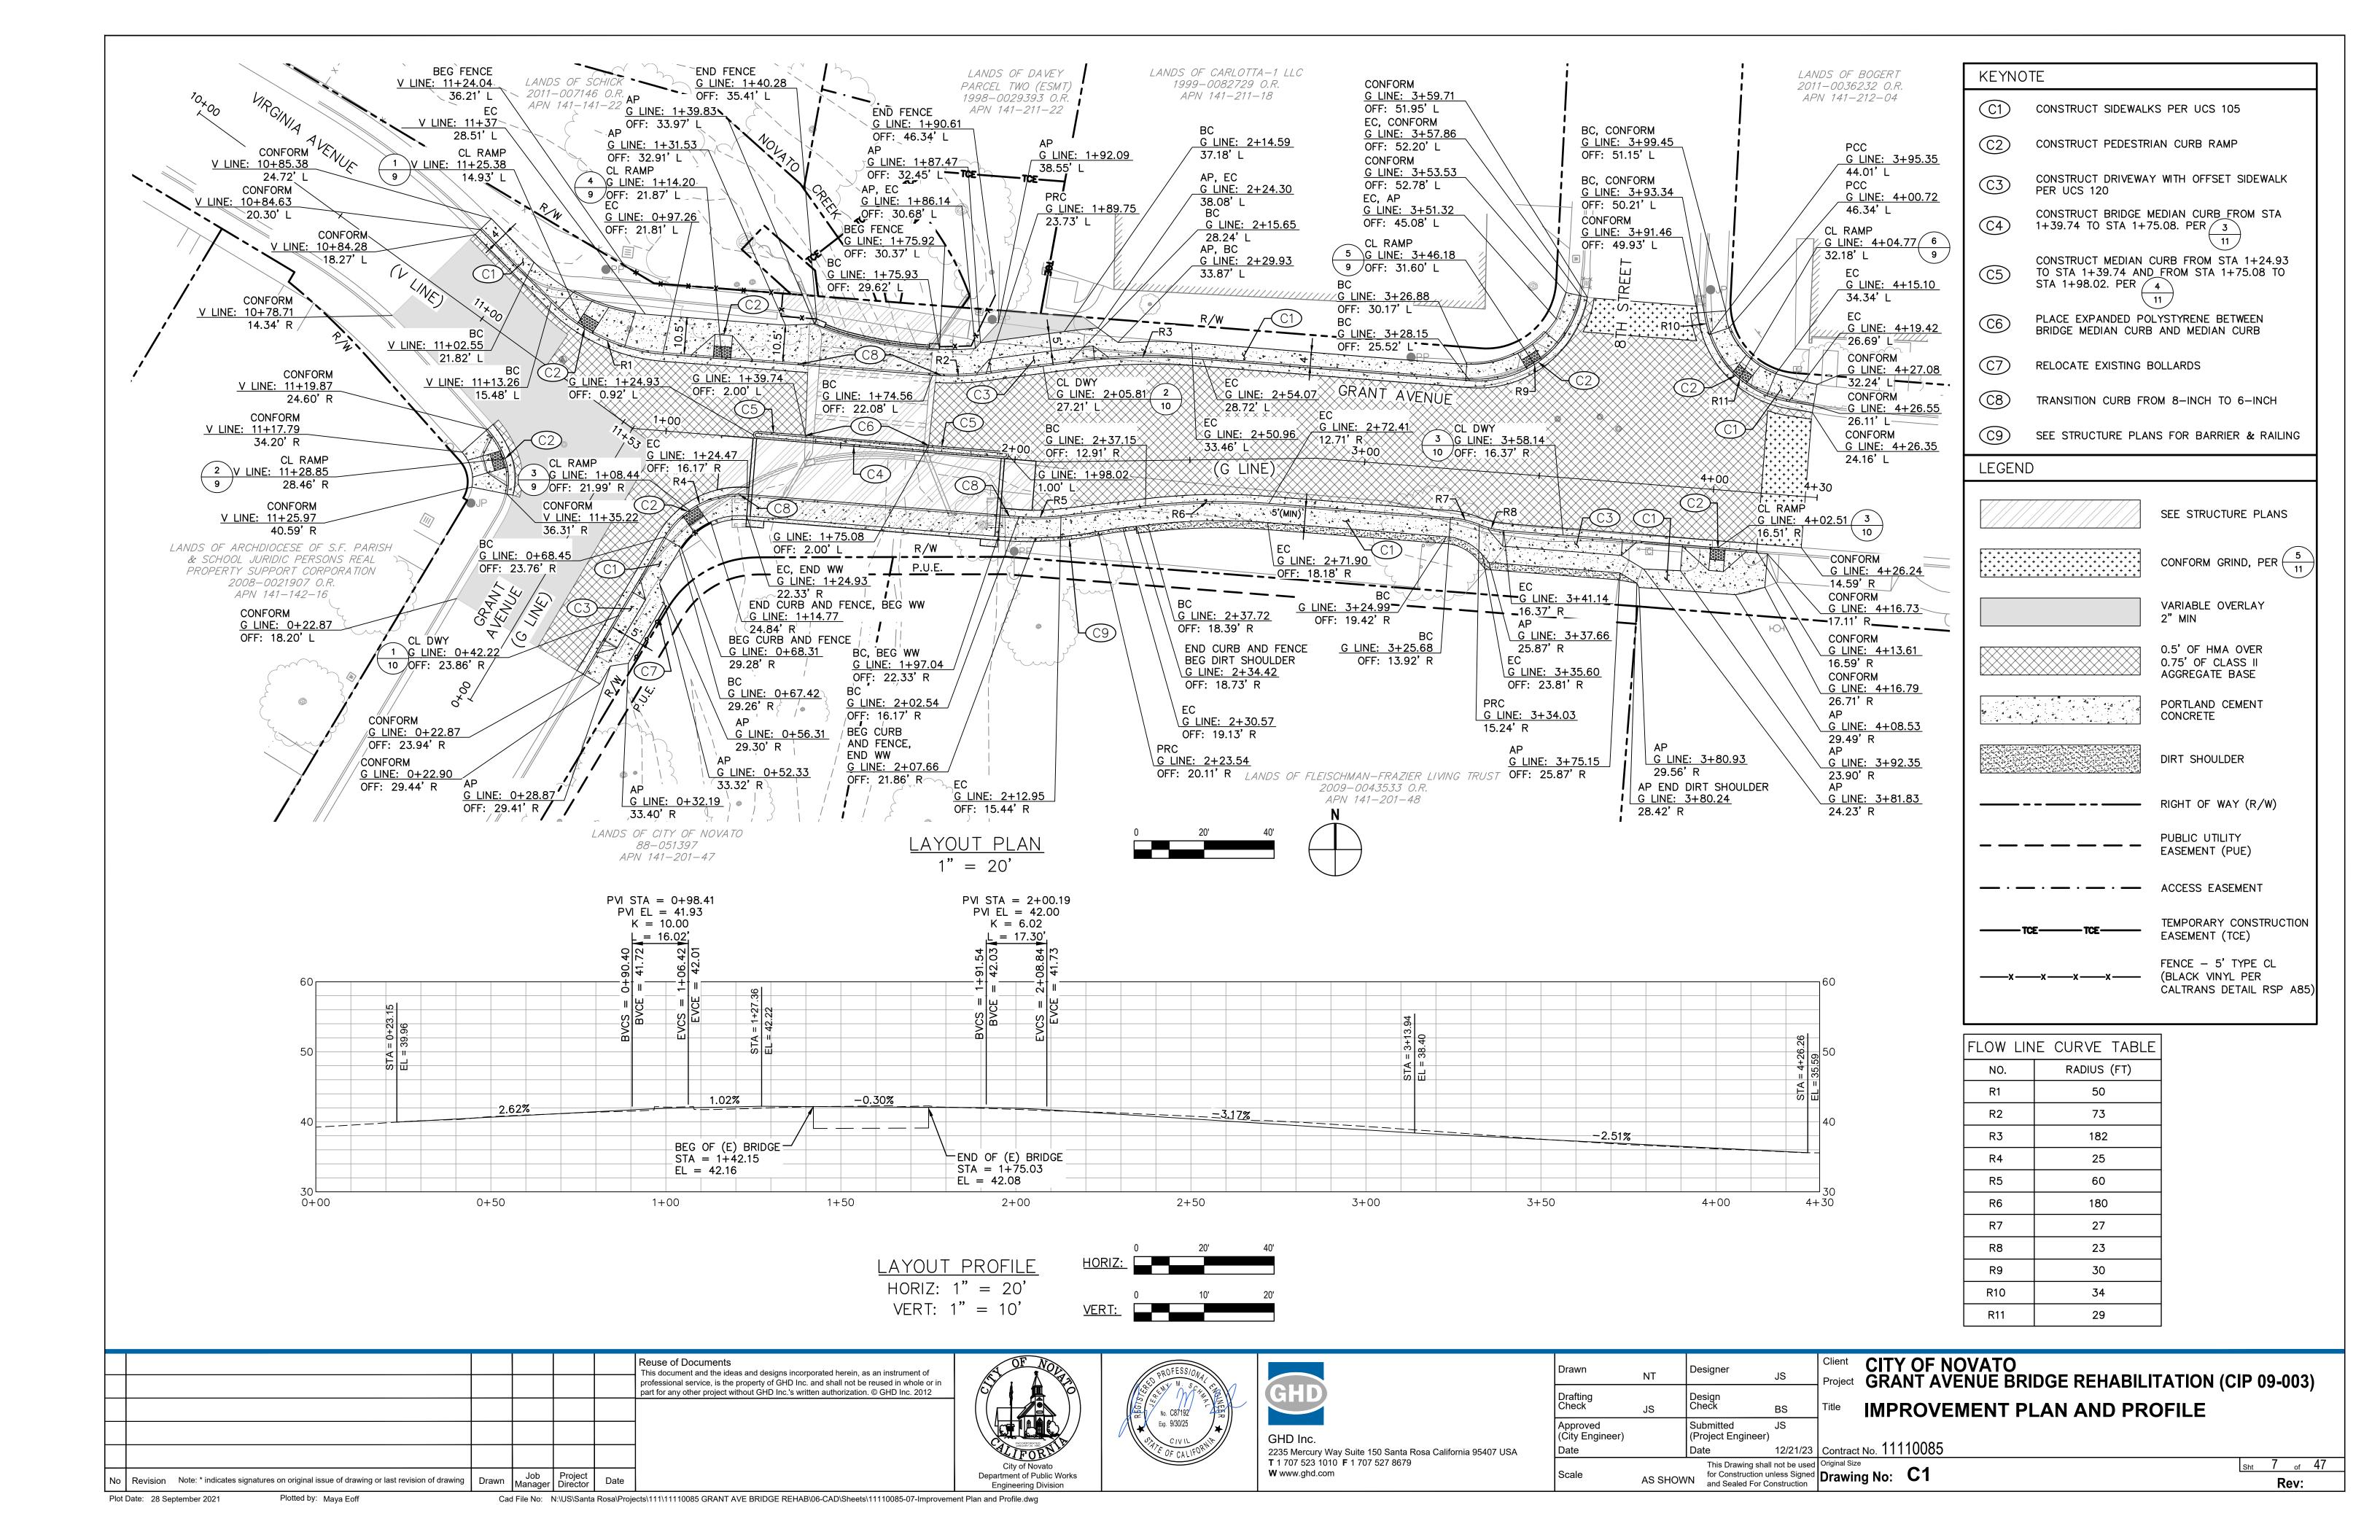


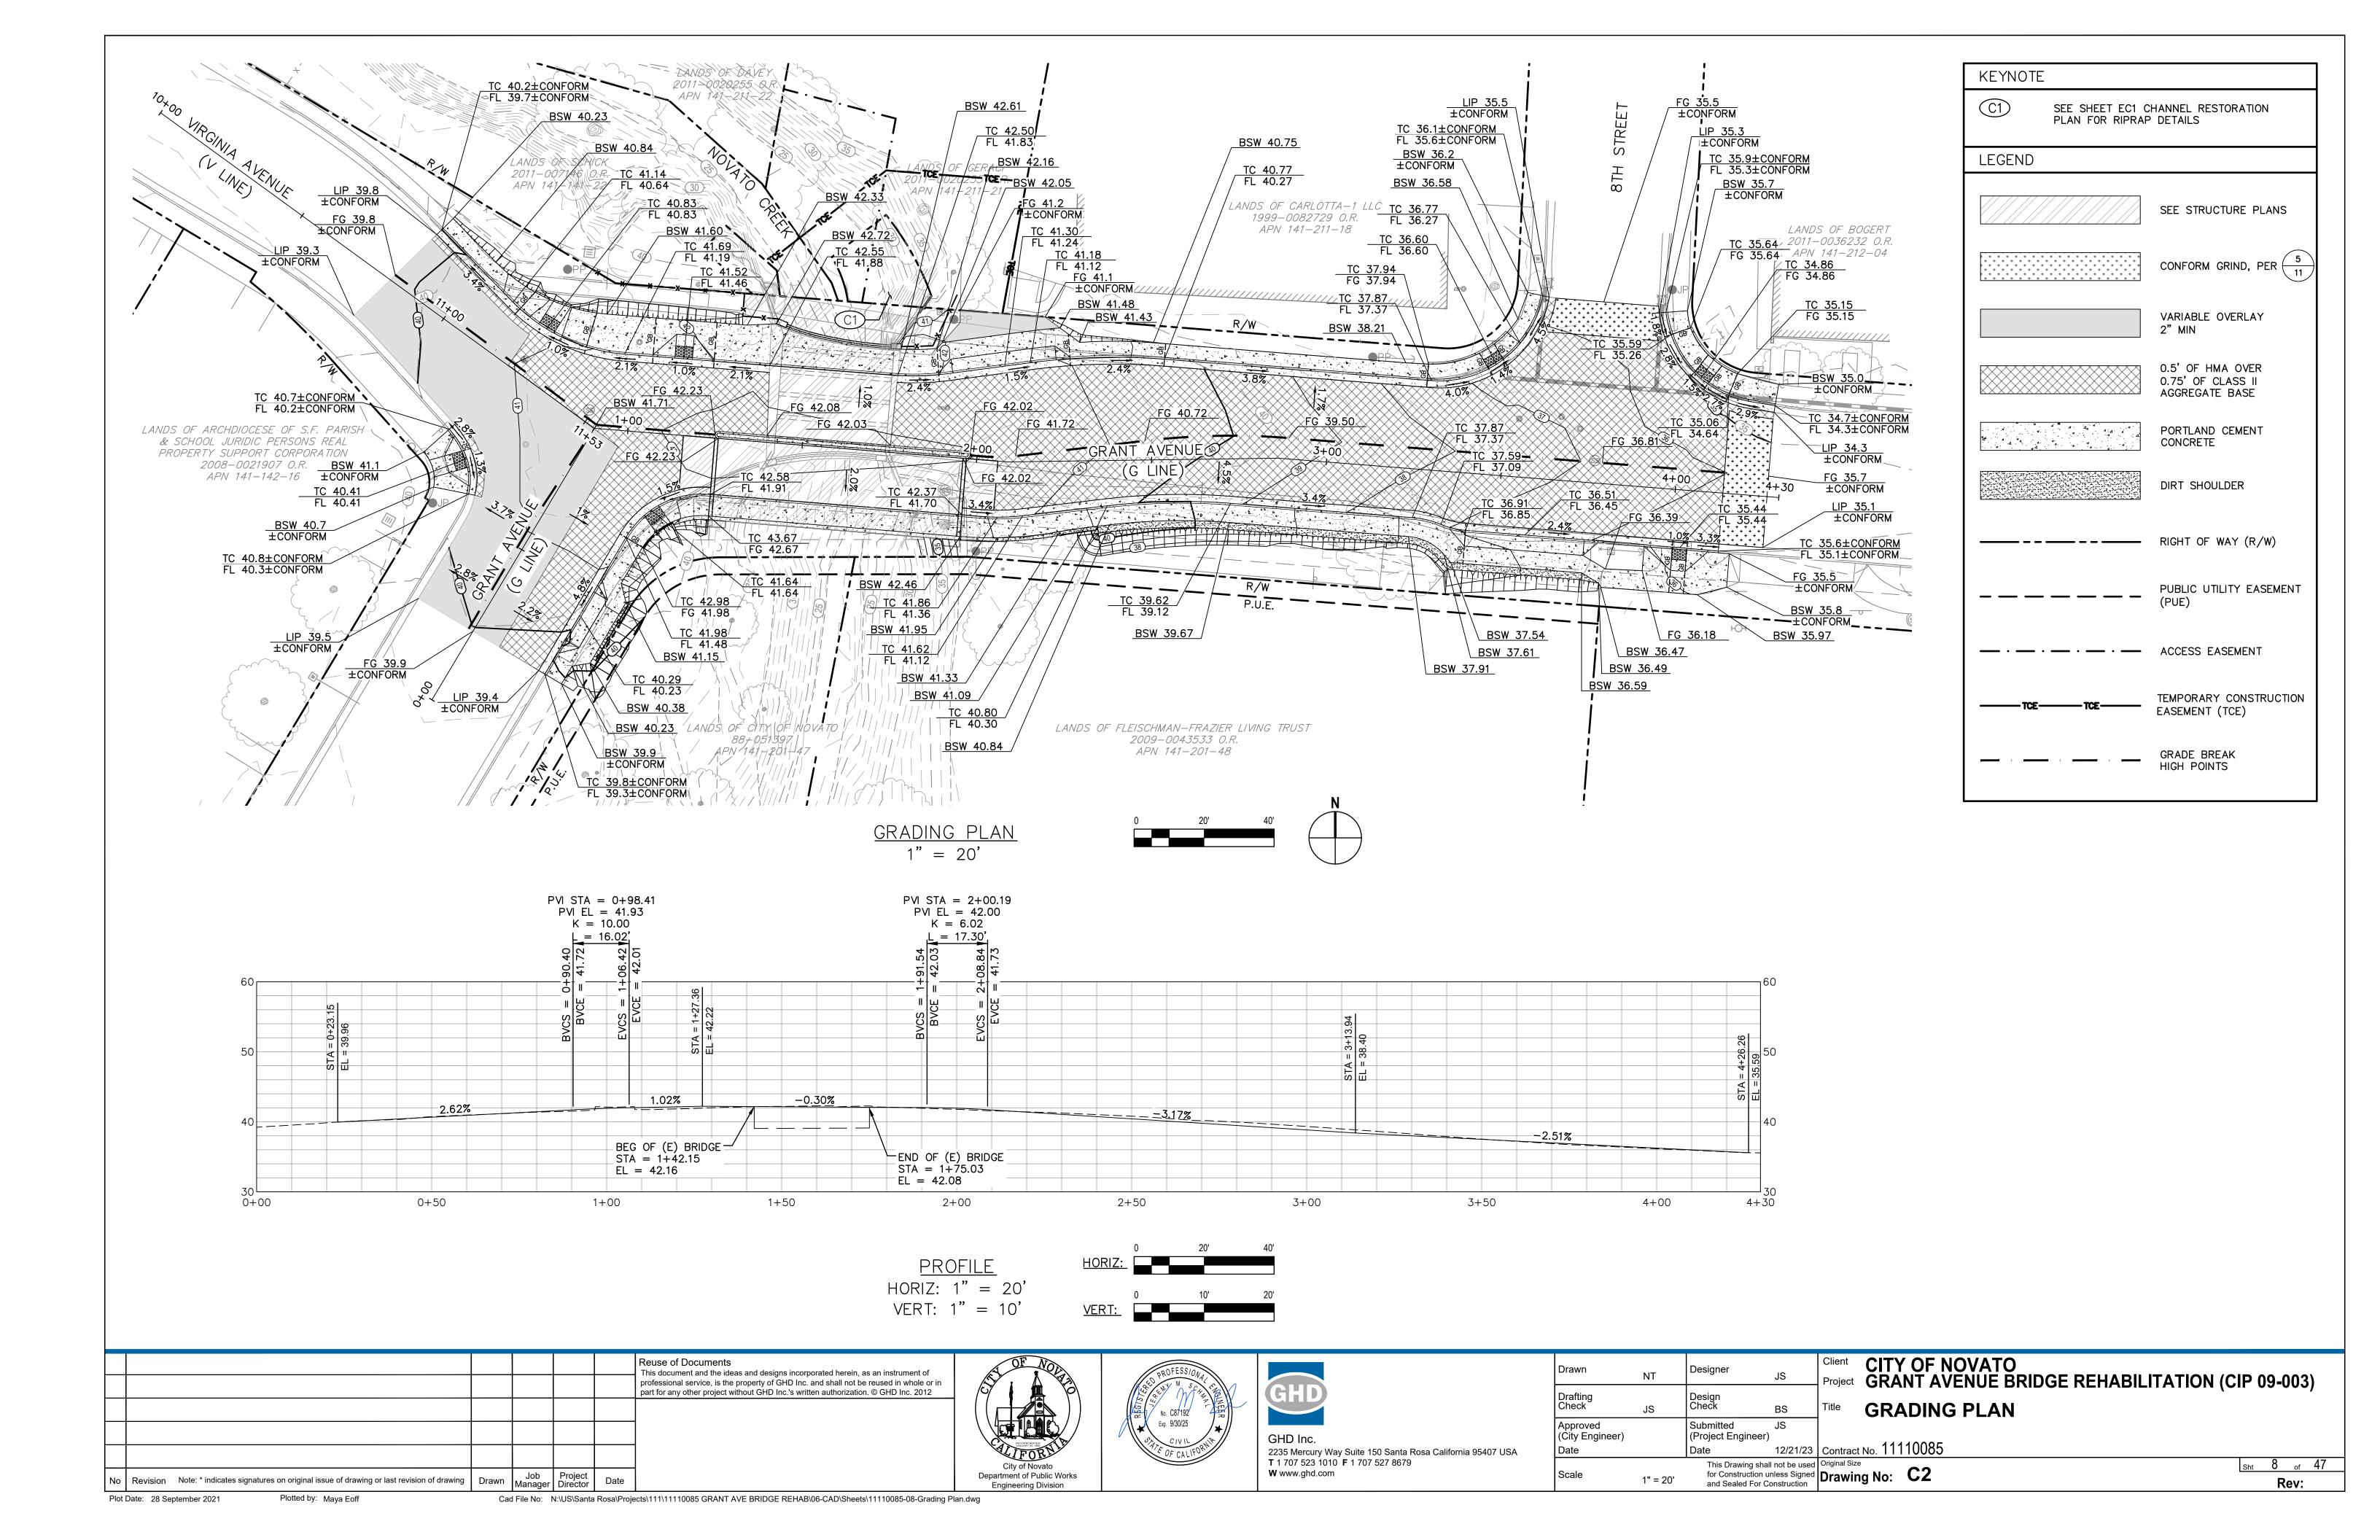

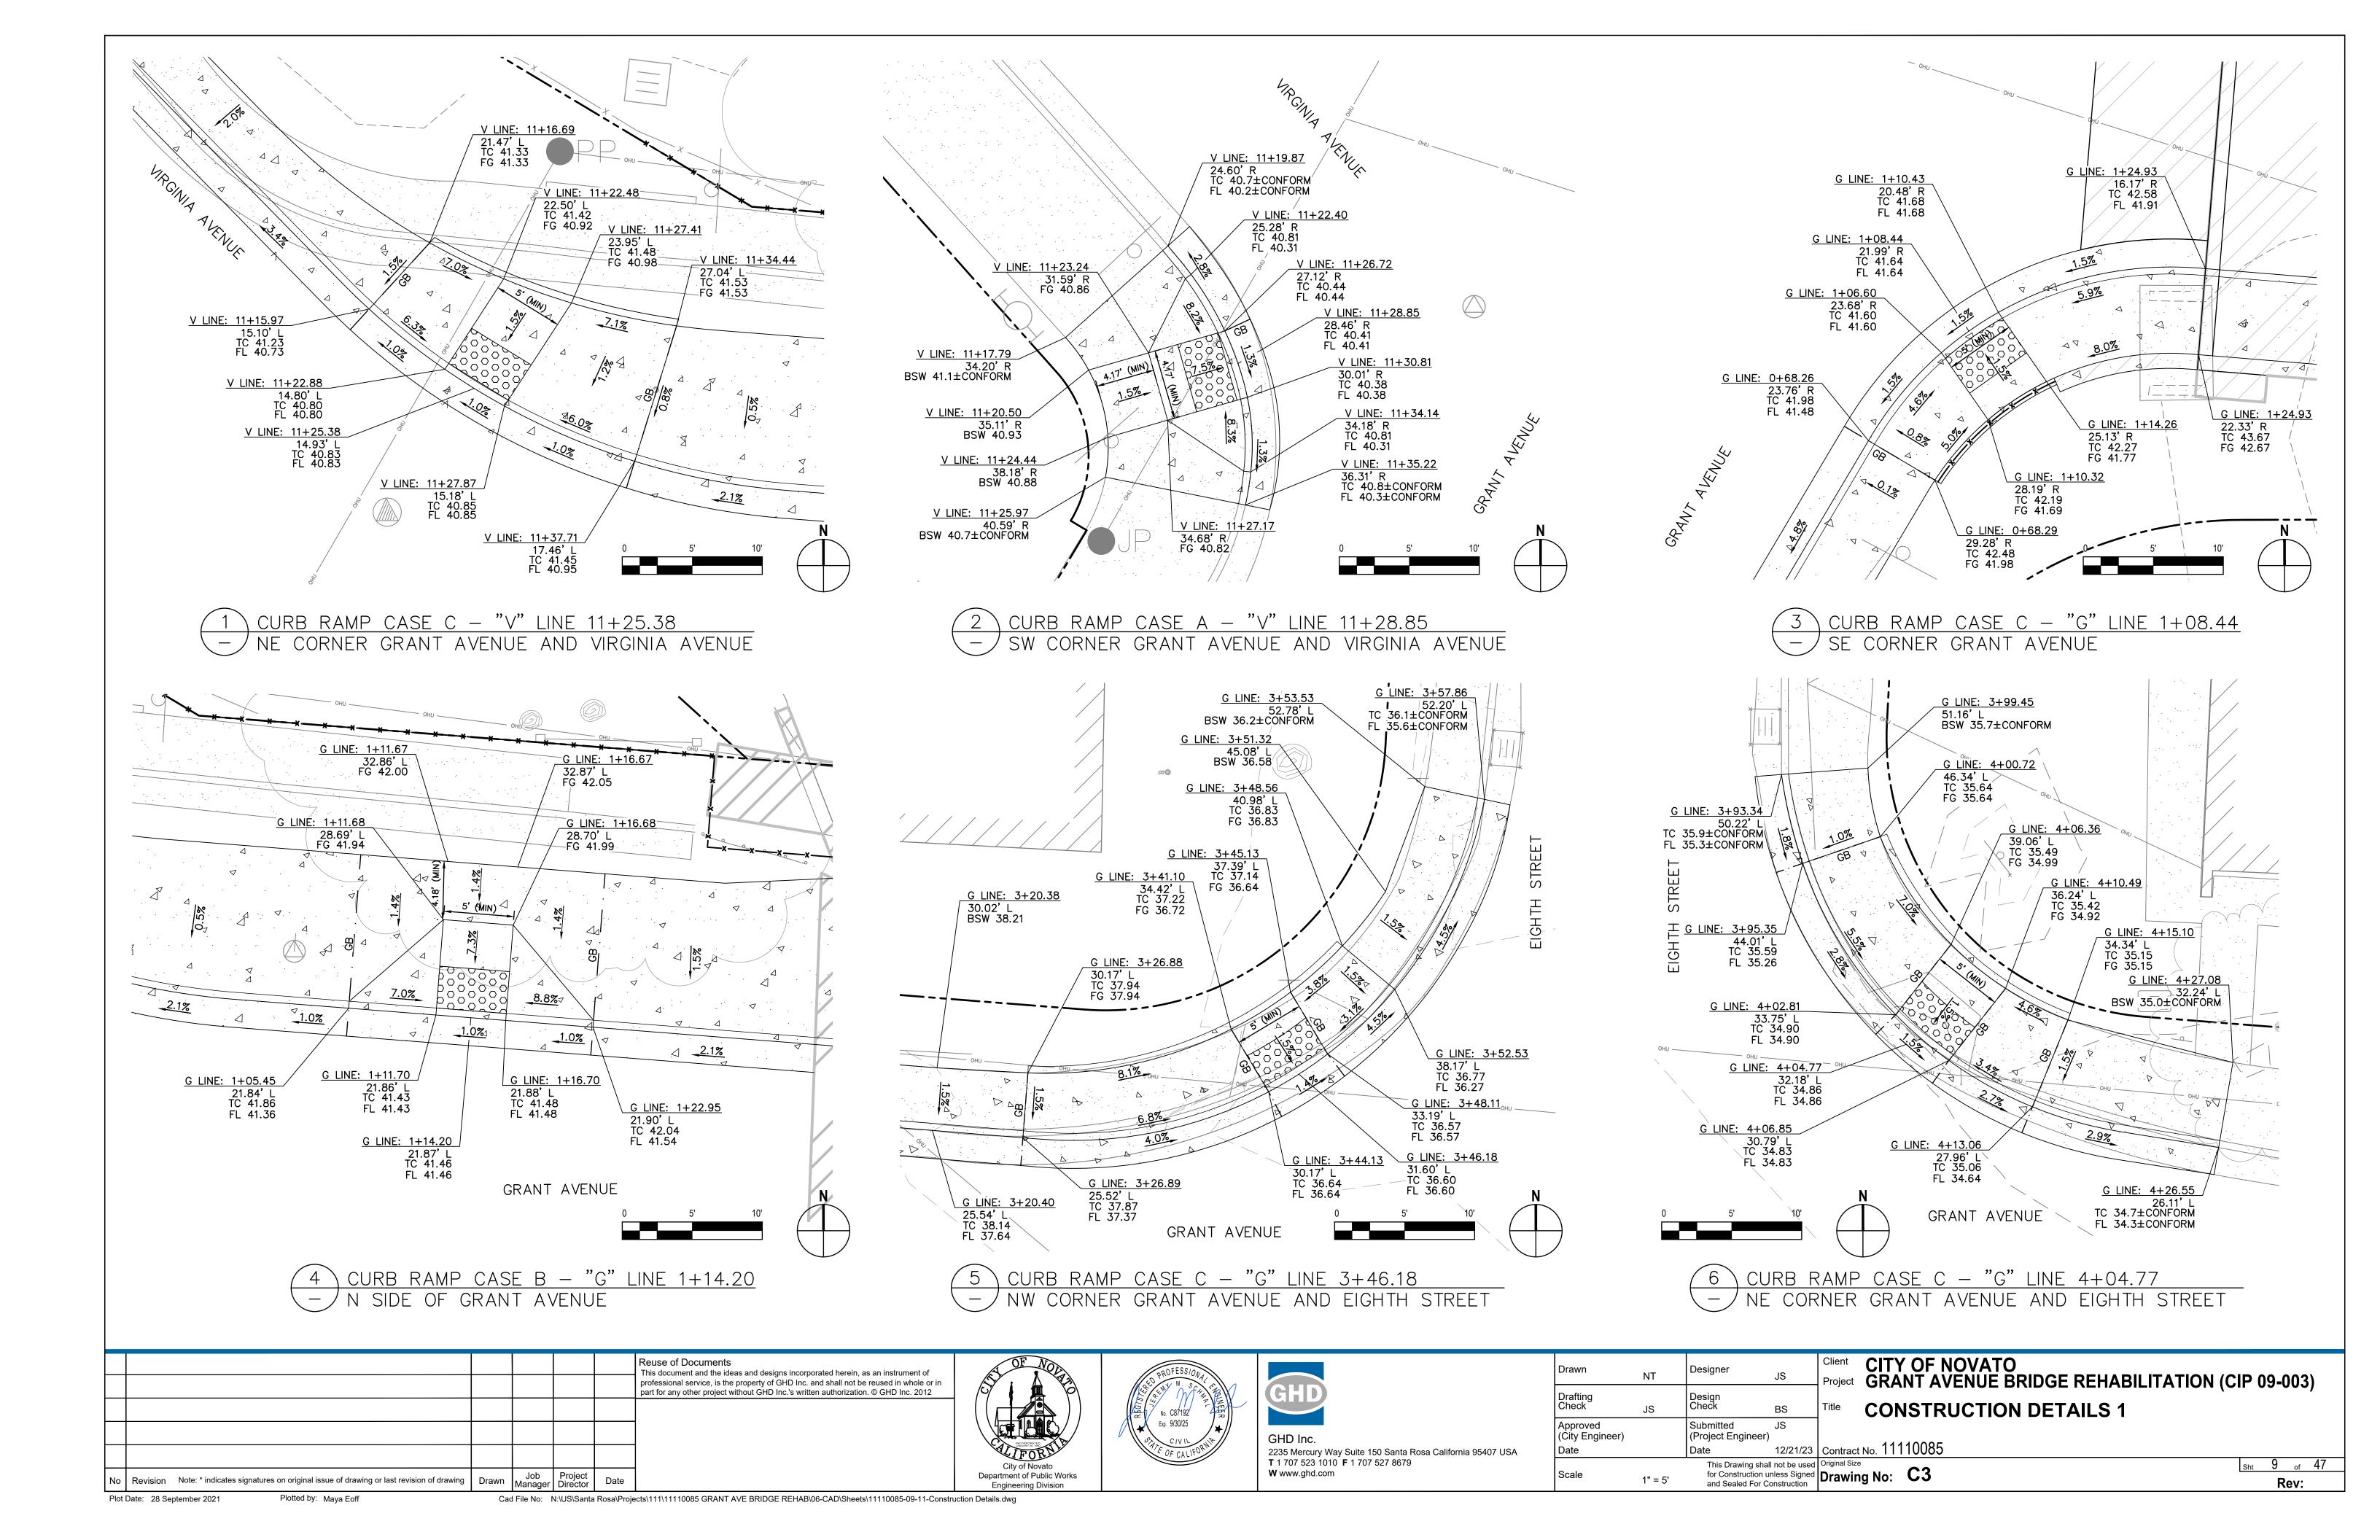

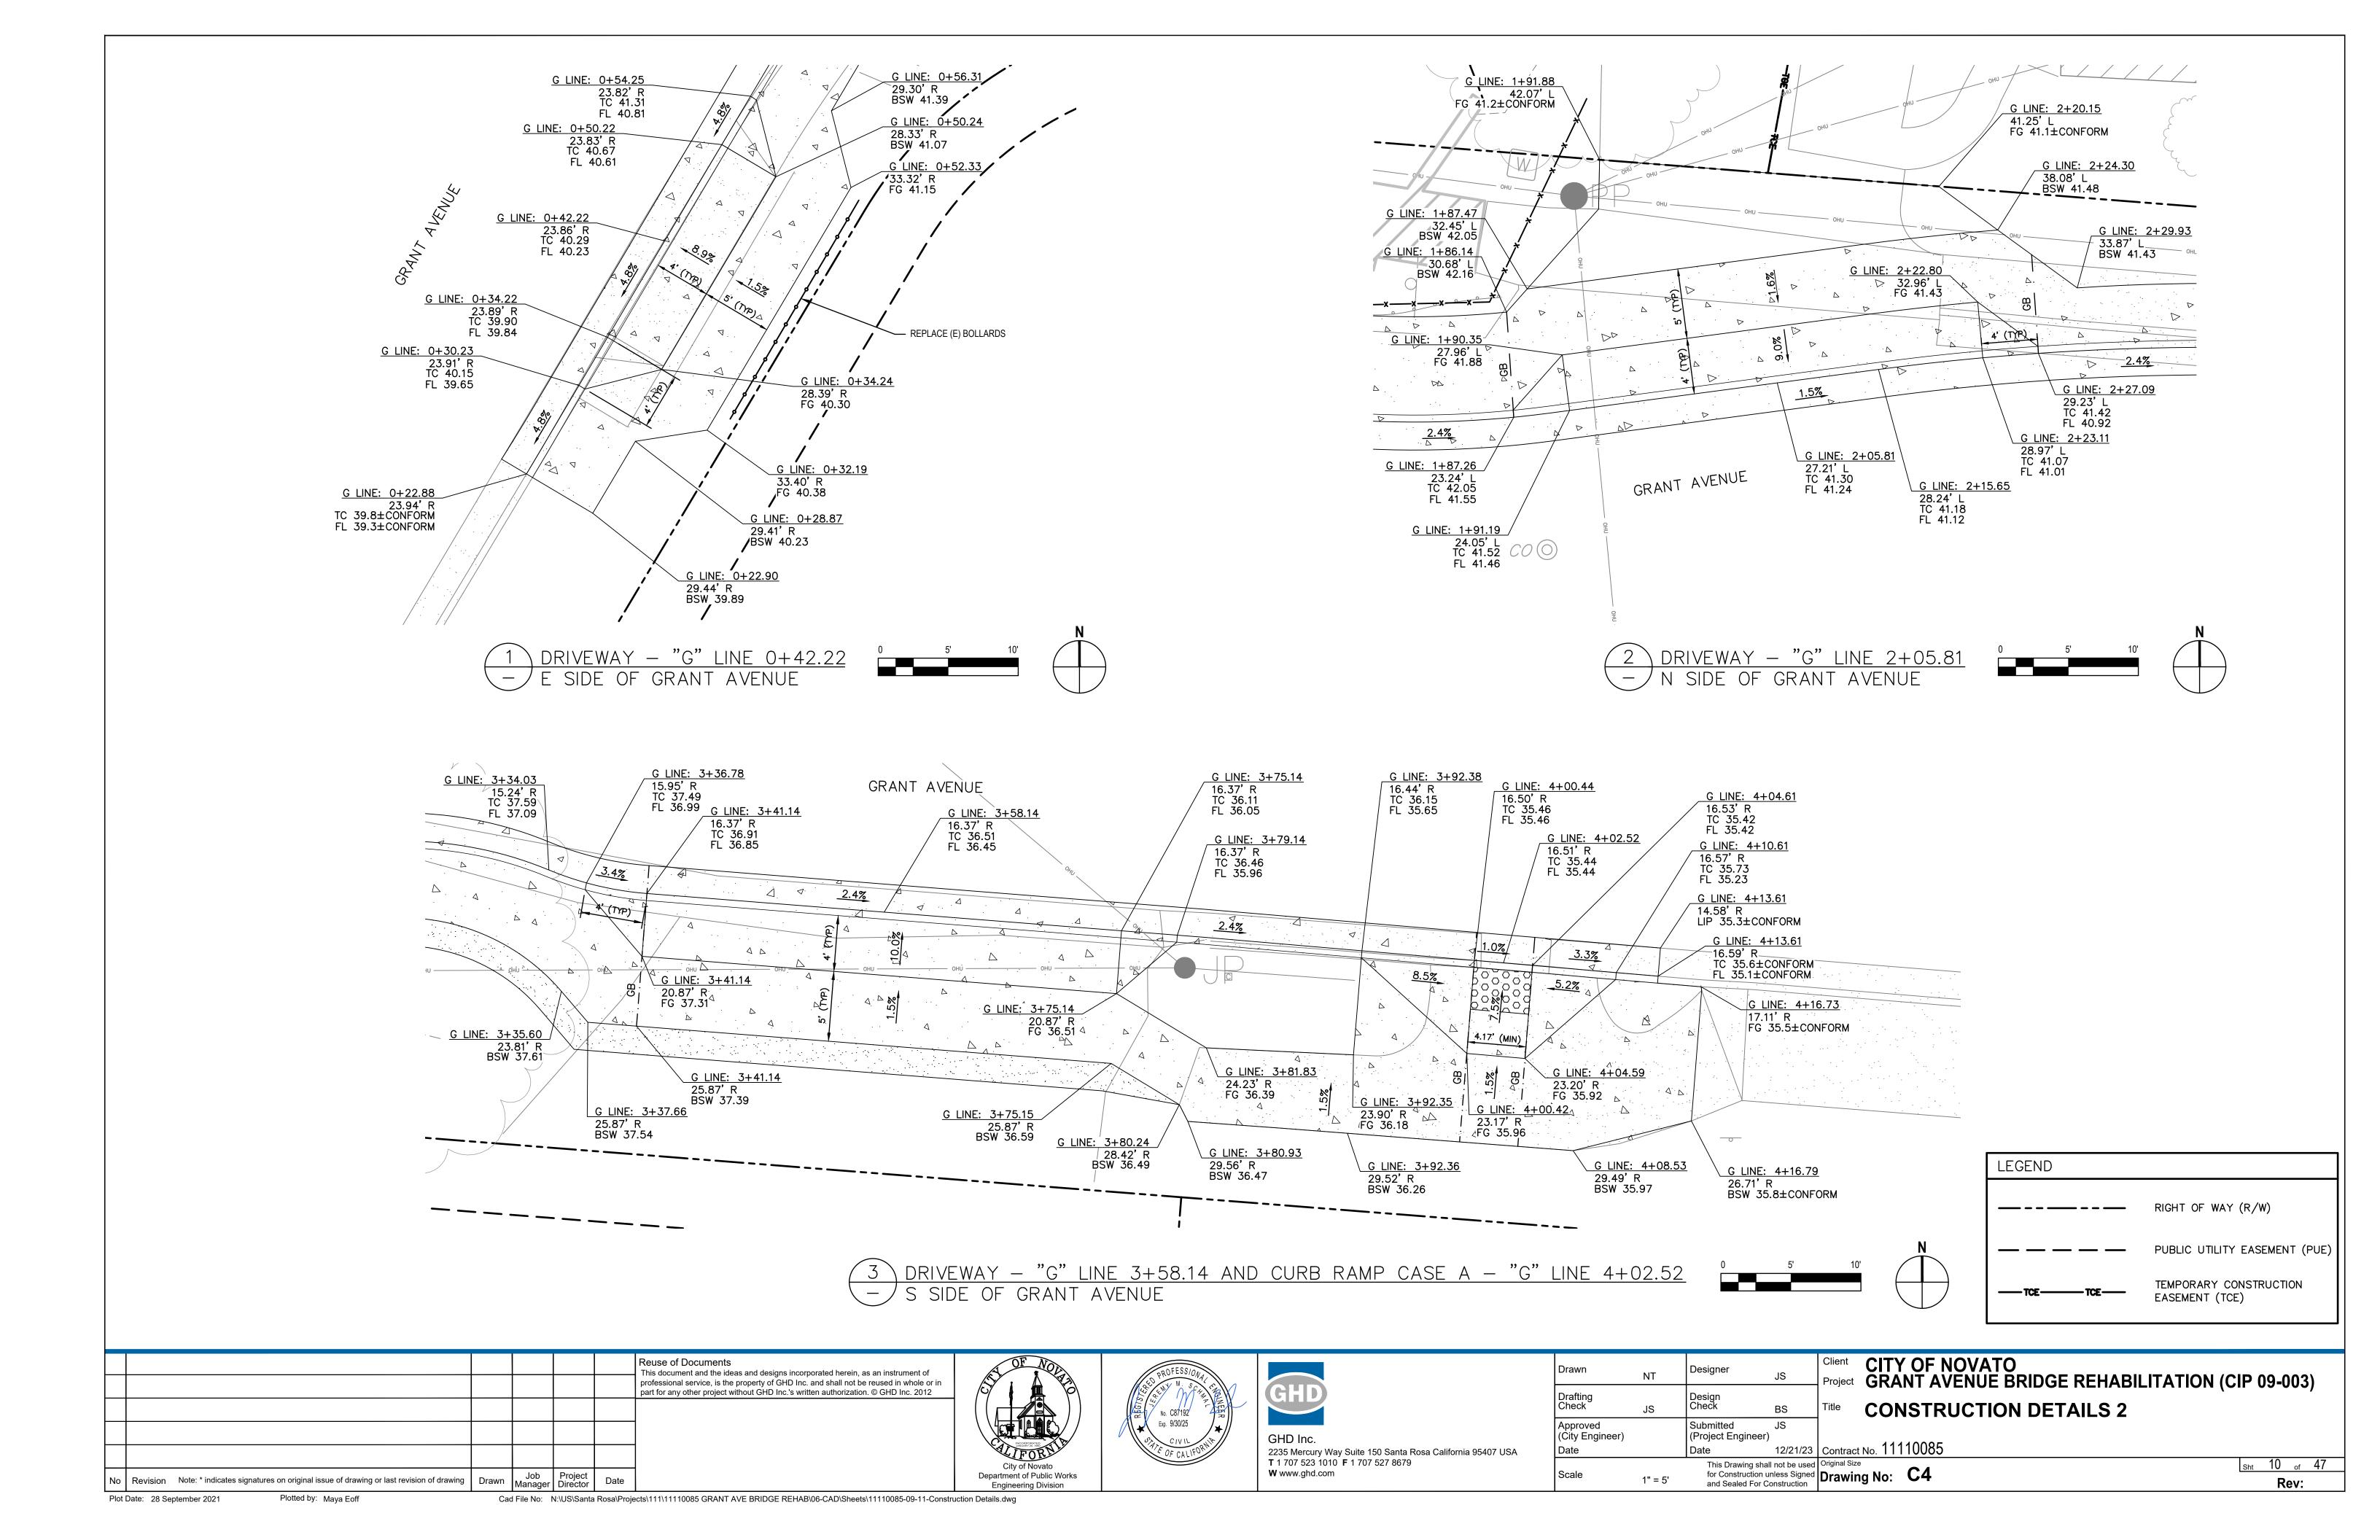




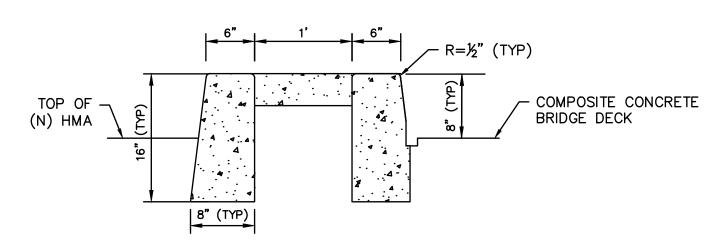


NOTE:

1. SEE UCS DWG NO 100 FOR GENERAL REQUIREMENTS


MEDIAN CURB - FROM STA 1+24.93 TO STA 1+39.74 AND FROM STA 1+75.08 TO STA 1+98.02 NTS

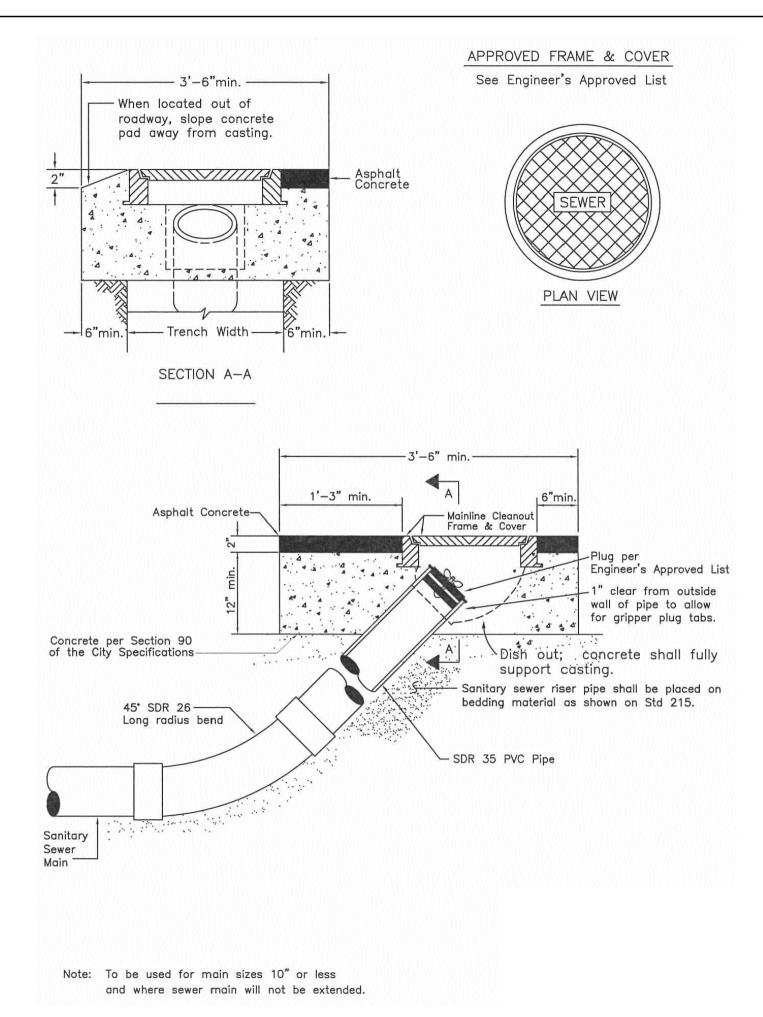



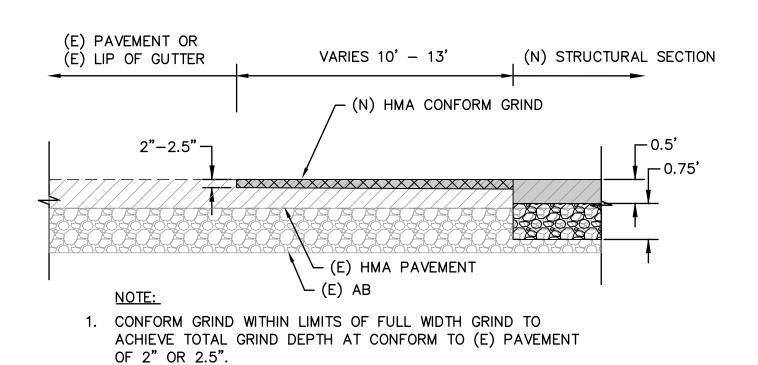



TYPICAL CONFORM GRIND

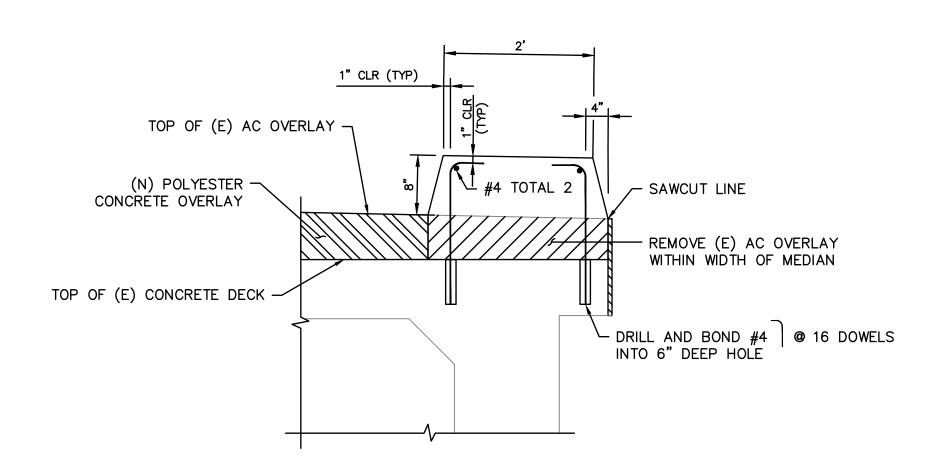

BRIDGE MEDIAN CURB - FROM STA 1+39.74 TO STA 1+75.08

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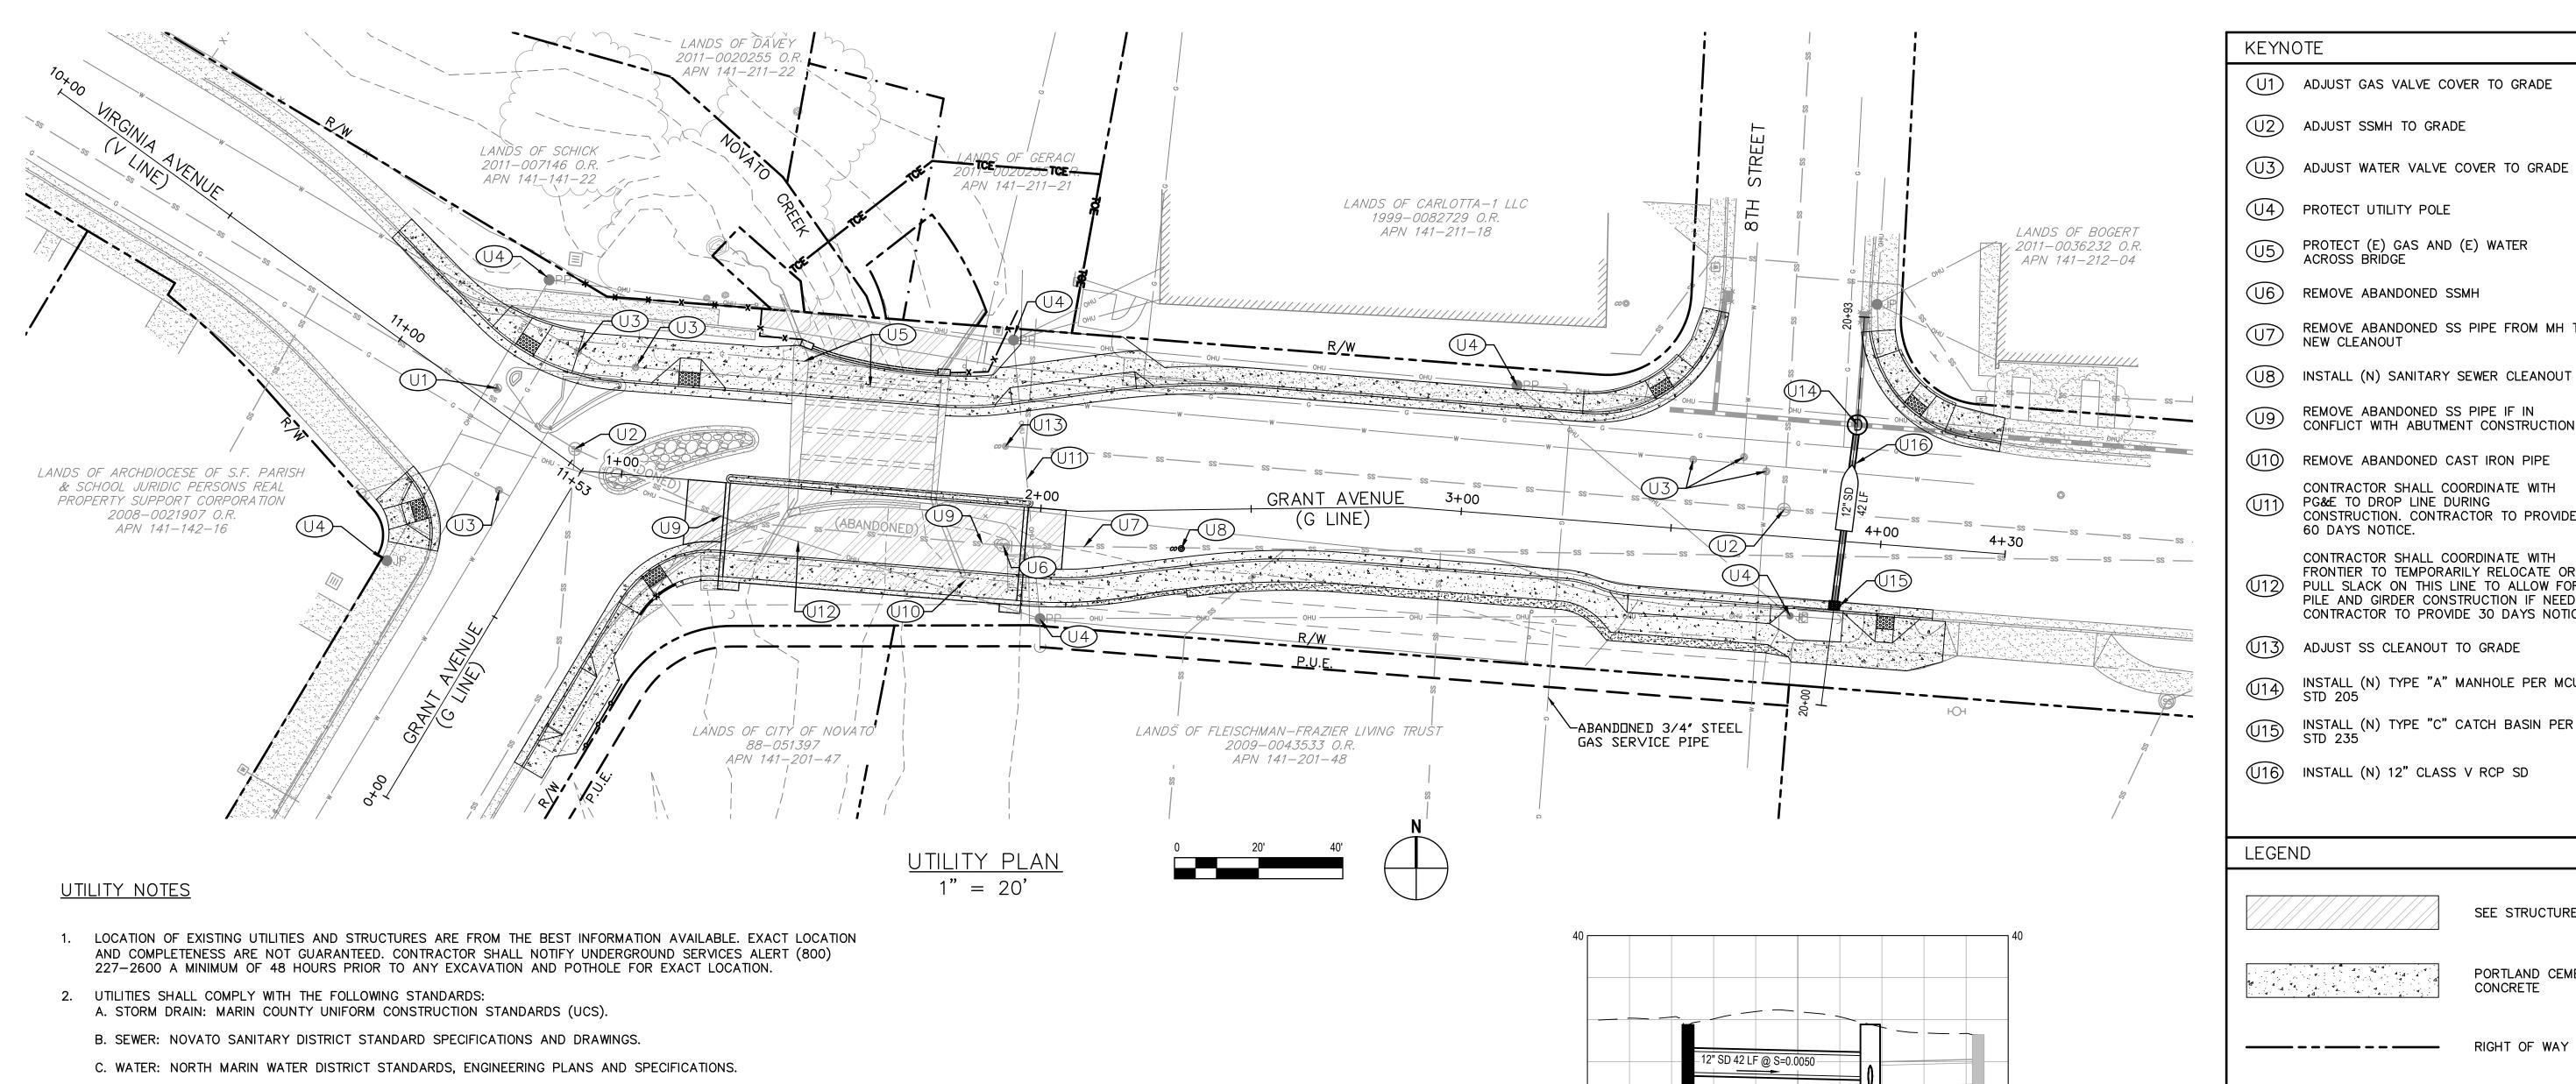
Drawn	NT	Designer	JS
Drafting Check	JS	Design Check	BS
Approved (City Engineer)		Submitted (Project Engineer)	JS
Date		Date	12/21/23
Scale	1" = 5'	This Drawing shall for Construction ur and Sealed For Co	nless Signed

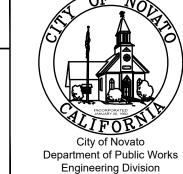Client CITY OF NOVATO
Project GRANT AVENUE BRIDGE REHABILITATION (CIP 09-003) **CONSTRUCTION DETAILS 3** 

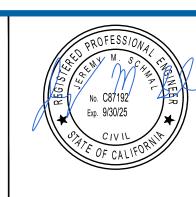
Contract No. 11110085

Sht 11 of 47 Drawing No: C5 Rev:

Cad File No: N:\US\Santa Rosa\Projects\111\11110085 GRANT AVE BRIDGE REHAB\06-CAD\Sheets\11110085-09-11-Construction Details.dwg




- D. STORM WATER TREATMENT AND CONTROL: BAY AREA STORMWATER MANAGEMENT AGENCIES ASSOCIATION (BASMAA) STANDARDS, POST-CONSTRUCTION MANUAL - DESIGN GUIDANCE FOR STORMWATER TREATMENT AND CONTROL FOR PROJECTS IN MARIN, SONOMA, NAPA AND SOLANO COUNTIES.
- 3. CONTRACTOR TO COORDINATE ANY TEMPORARY OR PERMANENT UTILITY RELOCATIONS WITH THE UTILITY OWNER.
- 4. COORDINATE WITH NMWD FOR REPLACEMENT OF 2 (E) LATERALS AFTER DEMOLITION OF SIDEWALK IS COMPLETE.
- 5. WORK RELATING TO THE ADJUSTMENT OF THE GAS VALVE COVER, SSMH, SS CLEANOUT AND WATER VALVE COVER ARE INCLUDED IN BID ALTERNATIVES 1—3 AS DESCRIBED IN THE CONTRACT DOCUMENTS.

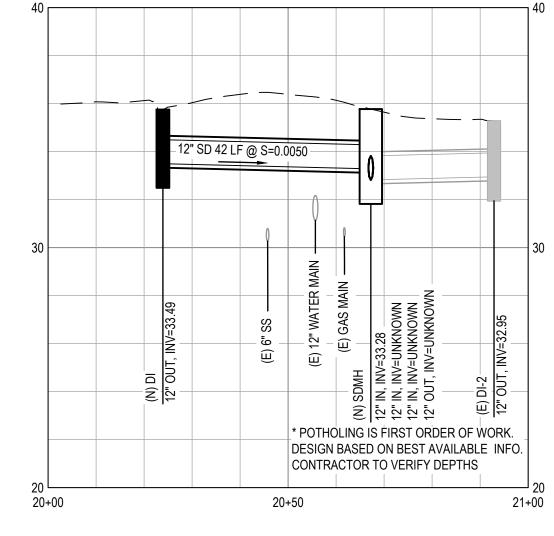

<u>UTILITY PROFILE - DRAINAGE SYSTEM</u> HORIZ: 1"=20', VERT: 1"=4'

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Scale	1" = 20'	This Drawing shall for Construction ur and Sealed For Co	nless Signed	Original Size  Drawin		U1

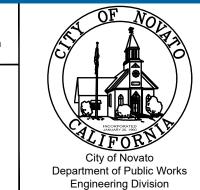Client	CITY OF NOVATO
Project	GRANT AVENUE BRIDGE REHABILITATION (CIP 09-003)
Title	UTILITY PLAN
	44440005

ADJUST SSMH TO GRADE

PROTECT (E) GAS AND (E) WATER ACROSS BRIDGE

REMOVE ABANDONED SS PIPE IF IN CONFLICT WITH ABUTMENT CONSTRUCTION

REMOVE ABANDONED CAST IRON PIPE

CONTRACTOR SHALL COORDINATE WITH

CONTRACTOR SHALL COORDINATE WITH FRONTIER TO TEMPORARILY RELOCATE OR PULL SLACK ON THIS LINE TO ALLOW FOR PILE AND GIRDER CONSTRUCTION IF NEEDED. CONTRACTOR TO PROVIDE 30 DAYS NOTICE.

ADJUST SS CLEANOUT TO GRADE

CONSTRUCTION. CONTRACTOR TO PROVIDE

INSTALL (N) TYPE "A" MANHOLE PER MCUCS STD 205

INSTALL (N) TYPE "C" CATCH BASIN PER MCUCS STD 235

SEE STRUCTURE PLANS

PORTLAND CEMENT

RIGHT OF WAY (R/W)

PUBLIC UTILITY

EASEMENT (PUE)

ACCESS EASEMENT

EASEMENT (TCE)

TEMPORARY CONSTRUCTION

CONCRETE

PG&E TO DROP LINE DURING

60 DAYS NOTICE.


REMOVE ABANDONED SS PIPE FROM MH TO NEW CLEANOUT

INSTALL (N) SANITARY SEWER CLEANOUT PER  $\left(\frac{2}{44}\right)$ 

REMOVE ABANDONED SSMH

| Contract No. 11110085


Sht 12 of 47 Rev:

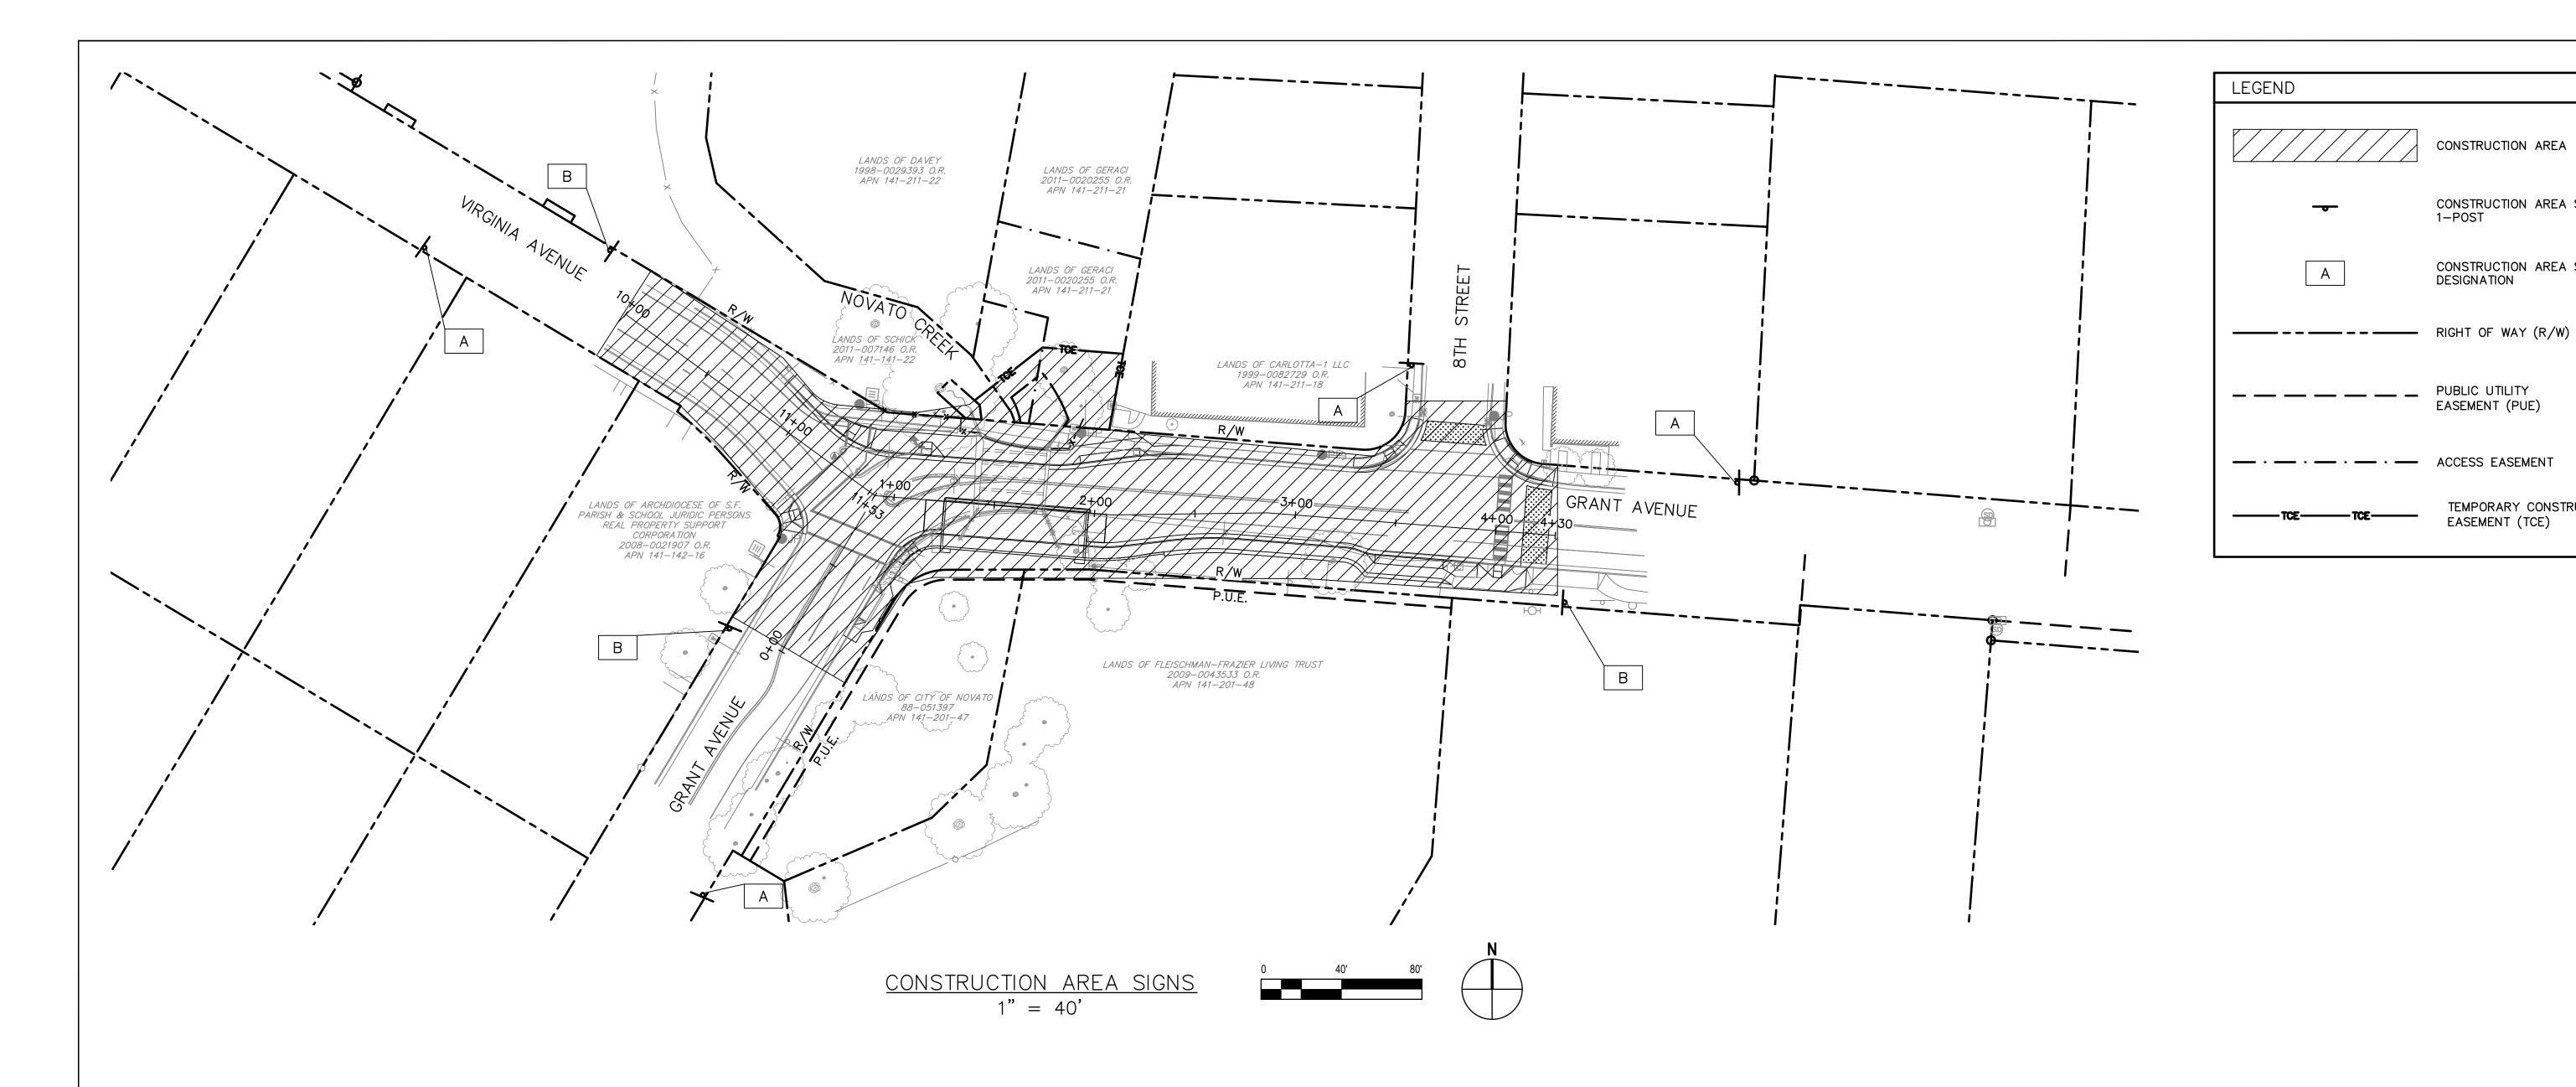


	CONSTRUCTION AREA SIG	SNS		
	TYPE	PANEL SIZE (IN X IN)	NO. OF POST AND SIZE (IN X IN)	EACH
Α	W20-1 (CA) "ROAD WORK AHEAD"	36 x 36	1 - 4 × 6	4
В	G20-1 (CA) "END ROAD WORK"	36 x 36	1 - 4 x 6	4

# CONSTRUCTION AREA SIGNS NOTES:

1. LOCATIONS OF CONSTRUCTION AREA SIGNS ARE APPROXIMATE. EXACT LOCATIONS WILL BE DETERMINED BY THE ENGINEER. ALL SIGN PLACEMENT AND LOCATION SHALL MEET REQUIREMENTS OF CA MUTCD AND CALTRANS STANDARD PLANS.

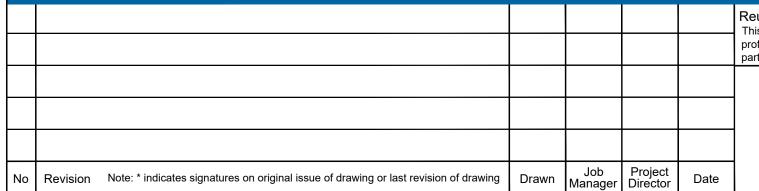

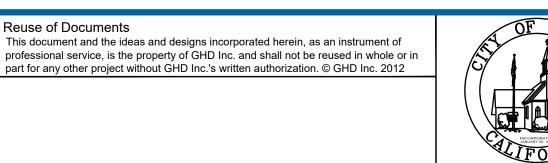

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Drafting Check	JS	Design Check	BS	Title		ISTRU
Approved (City Engineer)		Submitted (Project Engineer)	JS		444	40005
Date		Date	12/21/23	Contract	No. 111	10085
Scale	1" = 40'	This Drawing shall for Construction un and Sealed For Co	nless Signed		g No:	TH1

Client CITY OF NOVATO
Project GRANT AVENUE BRIDGE REHABILITATION (CIP 09-003) **CONSTRUCTION AREA SIGNS** 

Contract No. 11110085
Original Size

Sht 13 of 47 Rev:

CONSTRUCTION AREA

1-POST

DESIGNATION

PUBLIC UTILITY EASEMENT (PUE)


— · — · — ACCESS EASEMENT

CONSTRUCTION AREA SIGN,

CONSTRUCTION AREA SIGN

TEMPORARY CONSTRUCTION

EASEMENT (TCE)

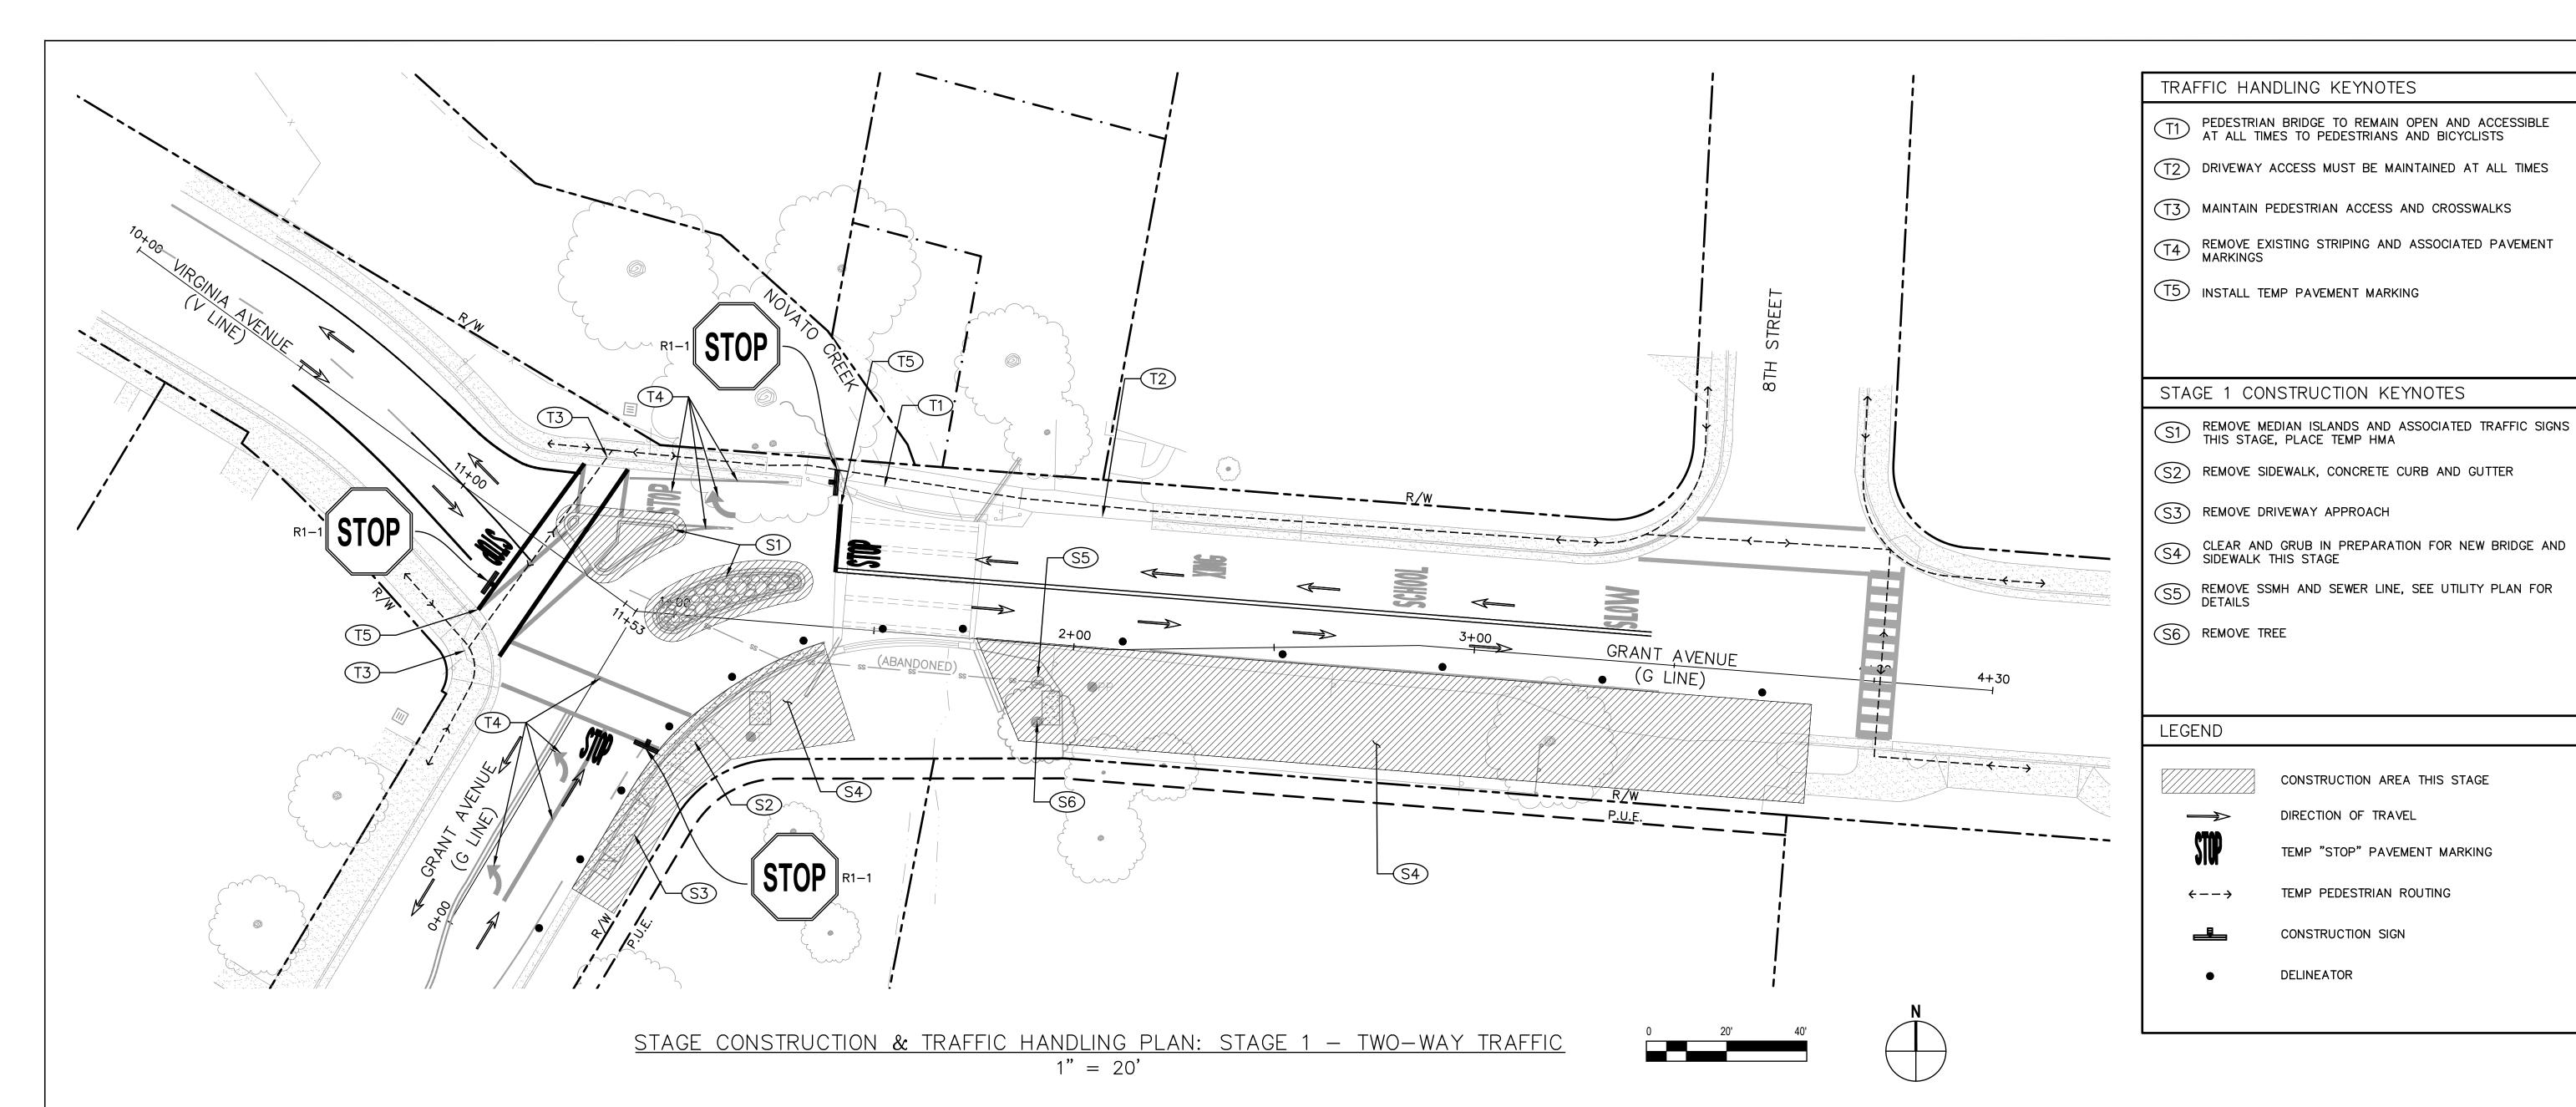

# GENERAL NOTES (ALL STAGE CONSTRUCTION SHEETS):

- 1. ALL PORTABLE CONSTRUCTION AREA SIGNS SHALL BE BLACK LETTERING ON ORANGE FIELD, EXCEPT ALL "R" SIGNS SHALL BE STANDARD COLORS.
- 2. PORTABLE CONSTRUCTION AREA SIGNS SHALL BE MOUNTED ON TYPE III BARRICADES WHERE SHOWN ON PLANS, OR ON WOOD POSTS.
- 3. CHANNELIZERS SHALL HAVE WHITE 2-WAY REFLECTORS ON 2-WAY ROADWAYS, WHITE 1-WAY REFLECTORS ON THE RIGHT SHOULDER OF DIVIDED ROADWAYS AND RAMPS AND YELLOW 1-WAY REFLECTORS ON THE LEFT SHOULDER OF DIVIDED HIGHWAYS AND RAMPS.
- 4. EXACT SIGN LOCATIONS TO BE DETERMINED BY THE ENGINEER.
- 5. CALIFORNIA SIGN CODES ARE DESIGNATED BY (CA), OTHERWISE, FEDERAL MUTCD SIGN CODES ARE SHOWN,
- 6. TEMPORARY STRIPING SHALL BE PAINT. REMOVE CONFLICTING STRIPING FROM PREVIOUS STAGES.
- 7. PLANS SHOW GENERAL REQUIREMENTS FOR MAINTENANCE OF TRAFFIC AND TRAFFIC CONTROL. THE CONTRACTOR IS RESPONSIBLE FOR TRAFFIC CONTROL AND MUST SUBMIT THEIR TRAFFIC CONTROL PLAN PROVIDING FULL DETAILS OF ALL TEMPORARY TRAFFIC CONTROL. SEE SPECIFICATIONS FOR ADDITIONAL TRAFFIC CONTROL REQUIREMENTS.

# SHEET NOTES:

- 1. MAINTAIN TWO-WAY TRAFFIC.
- 2. ONE-WAY FLAG CONTROL THROUGH INTERSECTION ACCEPTABLE DURING WORK HOURS.

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Approved (City Engineer) Date		Submitted (Project Engineer) Date	JS 12/21/23	Contract		N - S7 10085
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				1		

Client	CITY OF NOVATO
Project	<b>GRANT AVENUE BRIDGE REHABILITATION (CIP 09-003)</b>
itle	STAGE CONSTRUCTION AND TRAFFIC HANDLIN
	PLAN - STAGE 1 - TWO-WAY TRAFFIC

Sht 14 of 47

Rev:

CONSTRUCTION AREA THIS STAGE

TEMP "STOP" PAVEMENT MARKING

TEMP PEDESTRIAN ROUTING


DIRECTION OF TRAVEL

CONSTRUCTION SIGN

**DELINEATOR** 

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# TRAFFIC HANDLING KEYNOTES

- PEDESTRIAN BRIDGE TO REMAIN OPEN AND ACCESSIBLE AT ALL TIMES TO PEDESTRIANS AND BICYCLISTS
- DRIVEWAY ACCESS MUST BE MAINTAINED AT ALL TIMES
  - MAINTAIN PEDESTRIAN ACCESS AND CROSSWALKS
- GRANT AVENUE ONE-WAY WESTBOUND FROM 8TH STREET TO VIRGINIA AVENUE, PLACE DETOUR AS SHOWN ON
- INSTALL TEMP PAVEMENT MARKING
- PLACE TYPE K RAILING DURING NON-WORK HOURS THIS LOCATION
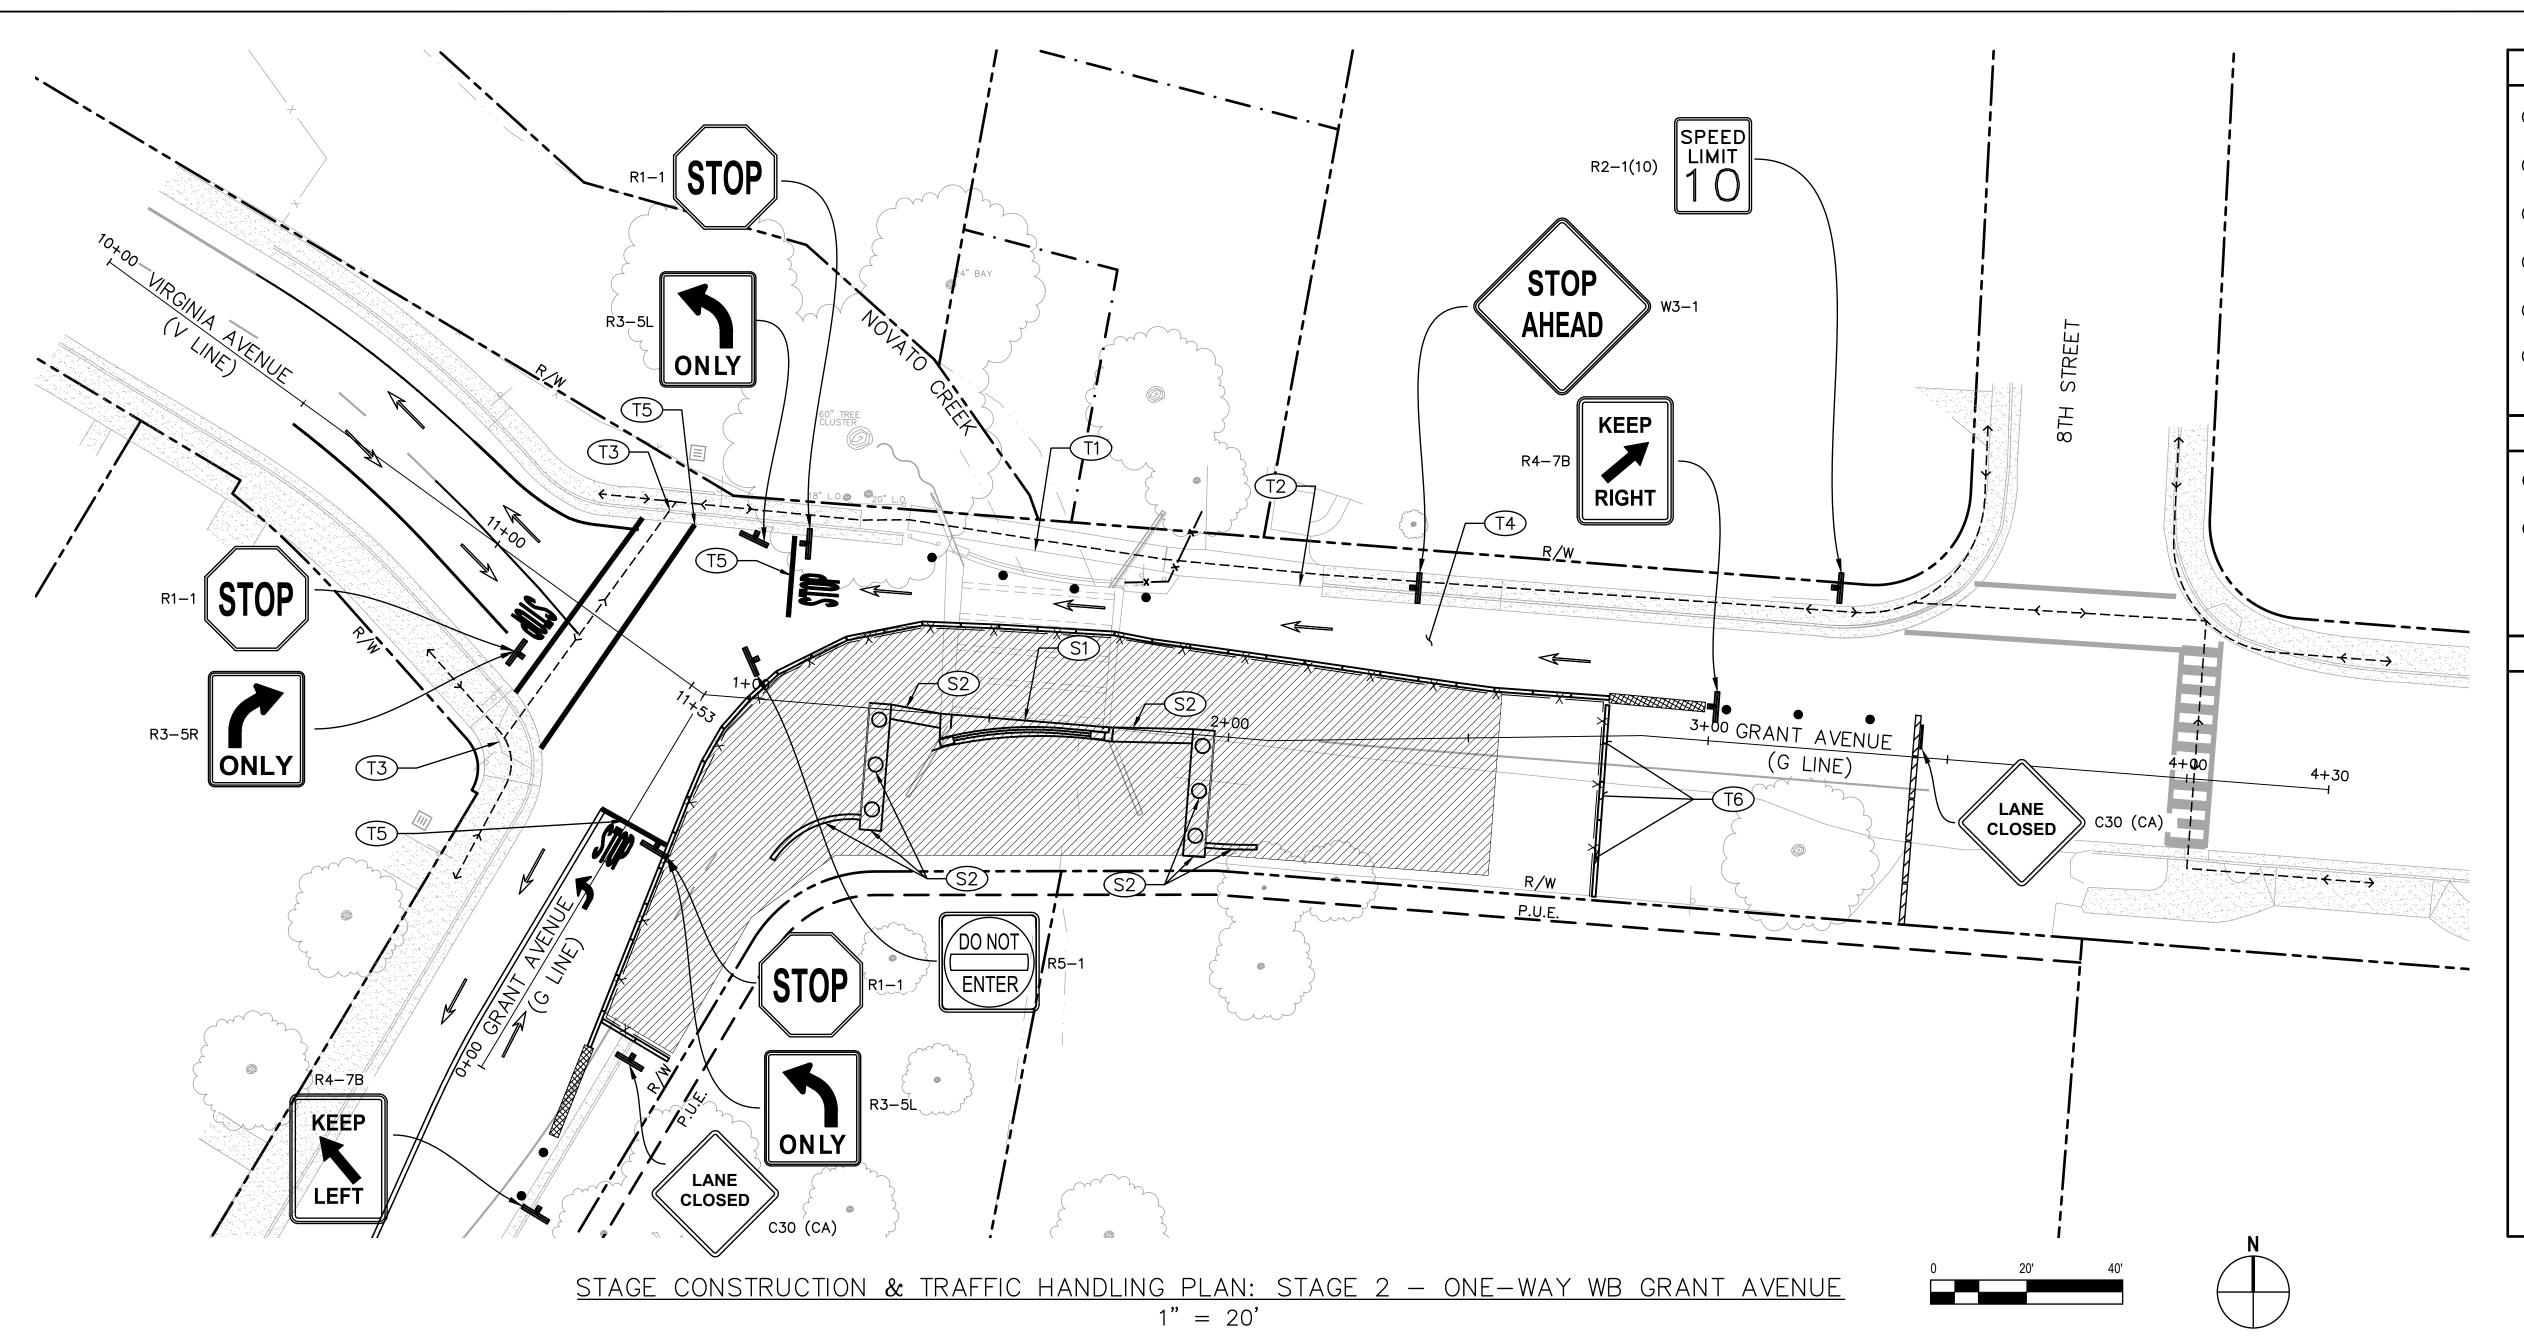
### STAGE 2 CONSTRUCTION KEYNOTES

- DEMOLISH SOUTHERLY PART OF EXISTING BRIDGE (SEE STRUCTURAL PLANS)
- CONSTRUCT PILES, ABUTMENTS AND WINGWALLS THIS PHASE (SEE STRUCTURAL PLANS)

# LEGEND

CONSTRUCTION AREA THIS STAGE

DIRECTION OF TRAVEL

SITE SECURITY FENCING WITH PRIVACY SCREENING

TEMP RAILING (TYPE K)

TEMP "STOP" PAVEMENT MARKING

TEMP TYPE IV PAVEMENT MARKING

TEMP PEDESTRIAN ROUTING

CONSTRUCTION SIGN

DELINEATOR


TEMPORARY CRASH CUSHION ABSORB 350 IN-LINE ARRAY OR APPROVED EQUAL


TYPE 3 BARRICADE

# SHEET NOTES:

- REMOVE ANY CONFLICTING STRIPING, EXISTING OR NO PARKING FROM PREVIOUS STAGE.
- FOR ADDITIONAL SIGNAGE NOT SHOWN, SEE DETOUR PLAN 1 ON SHEET 19.

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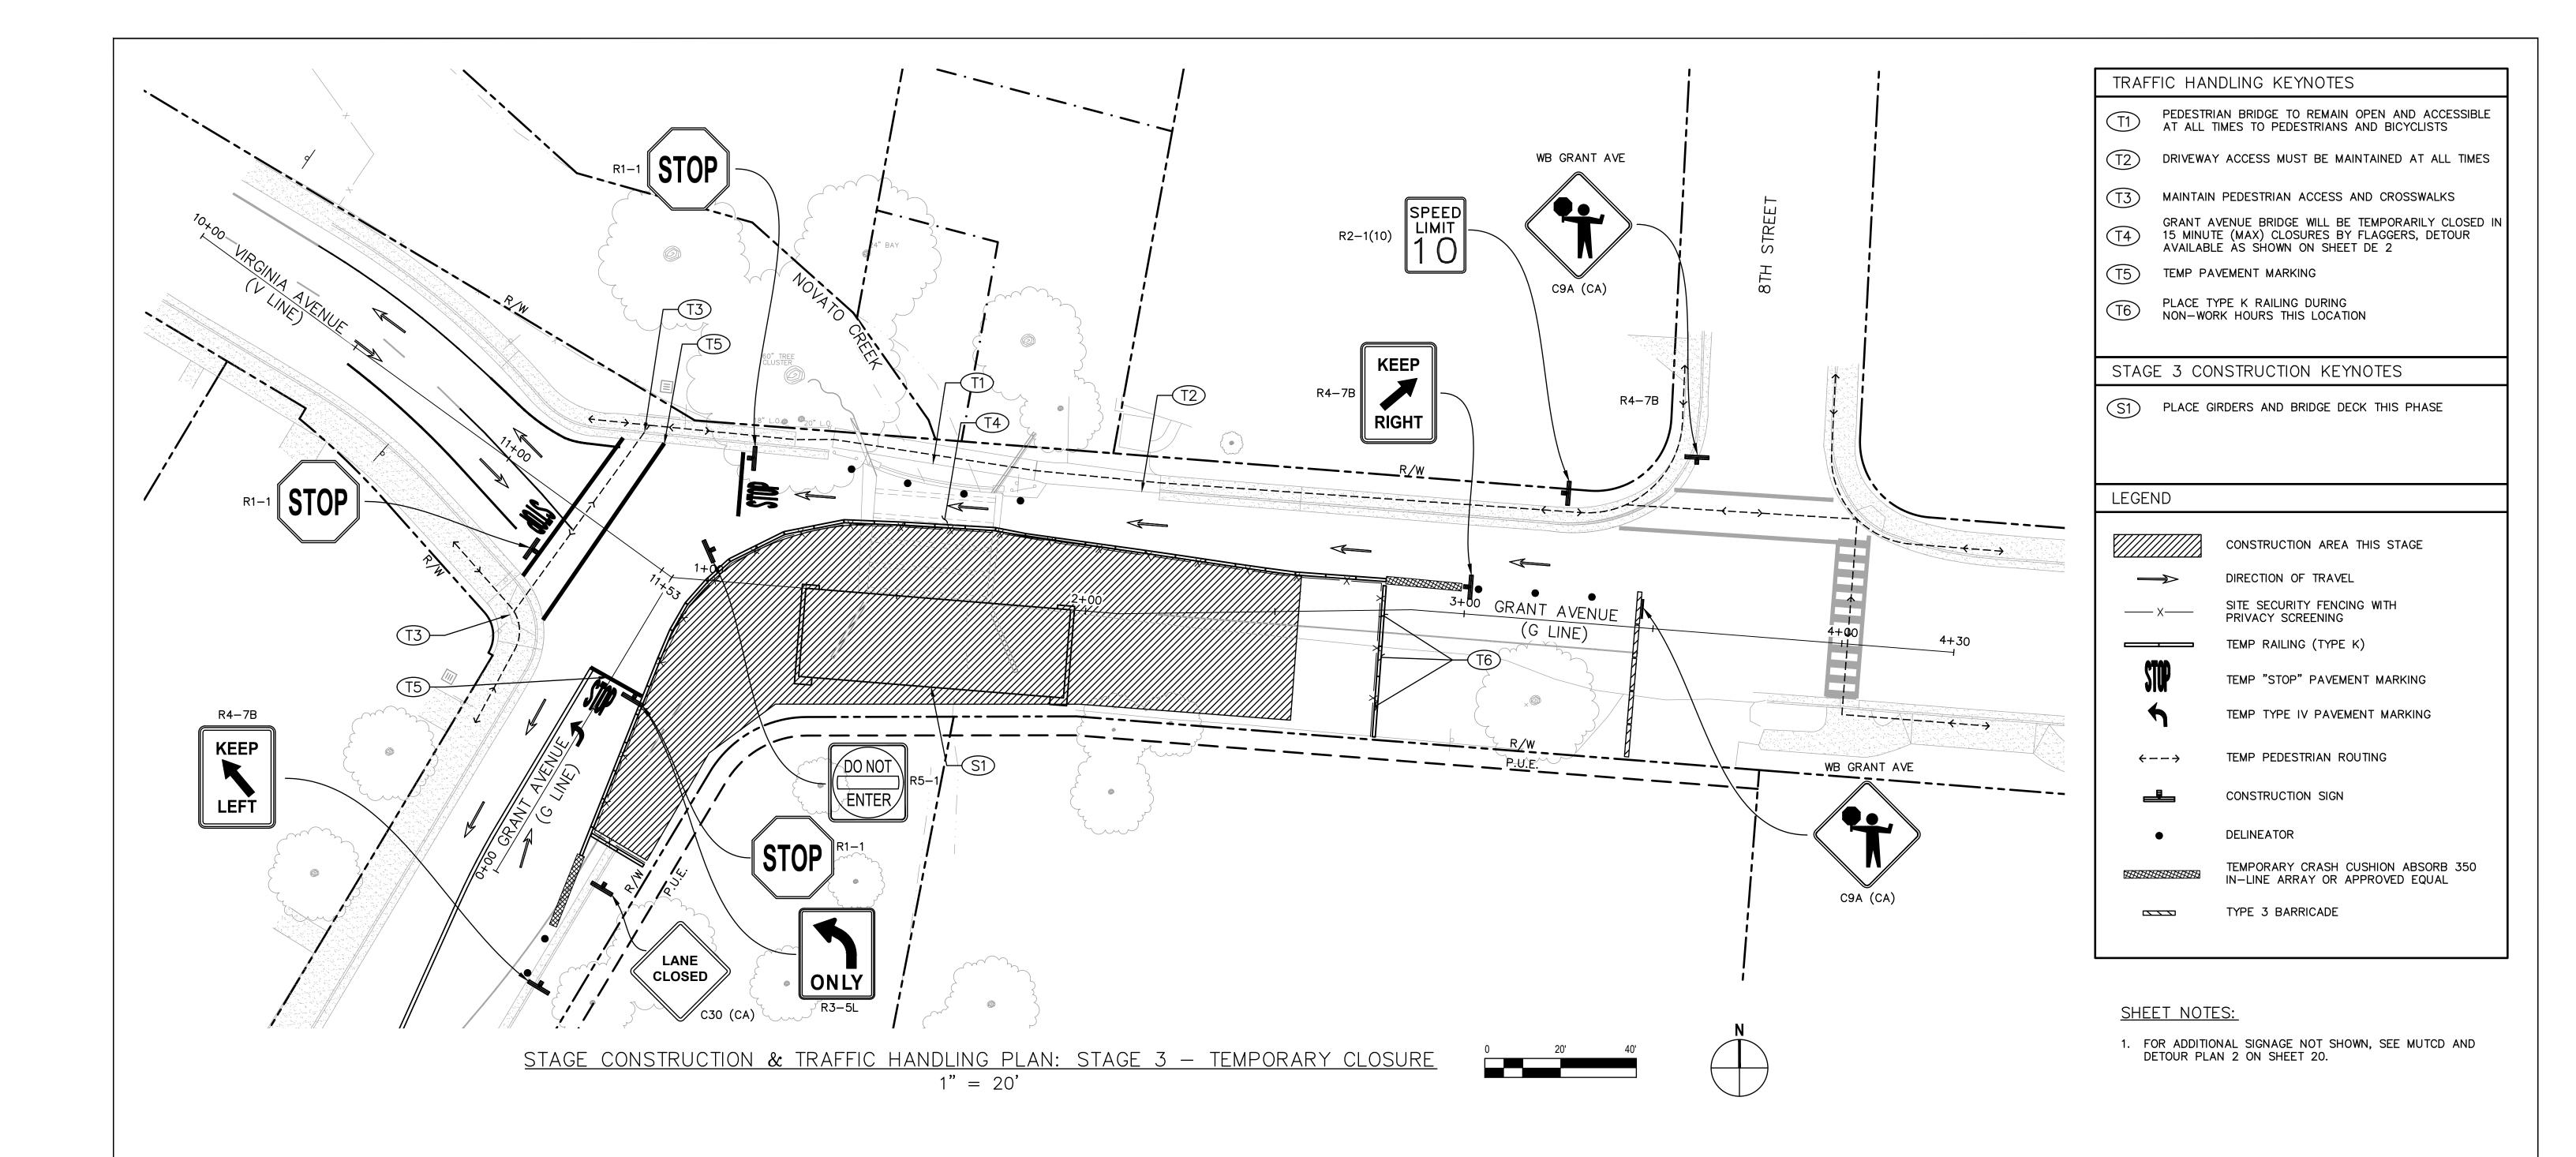


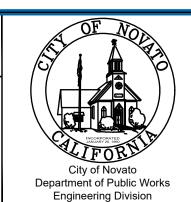

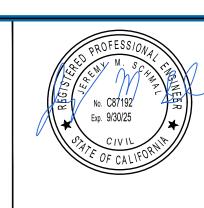
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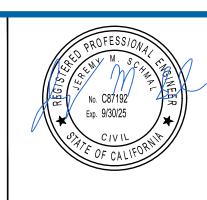
Client CITY OF NOVATO
Project GRANT AVENUE BRIDGE REHABILITATION (CIP 09-003) STAGE CONSTRUCTION AND TRAFFIC HANDLING **PLAN - STAGE 2 - ONE-WAY WB GRANT AVENUE** 

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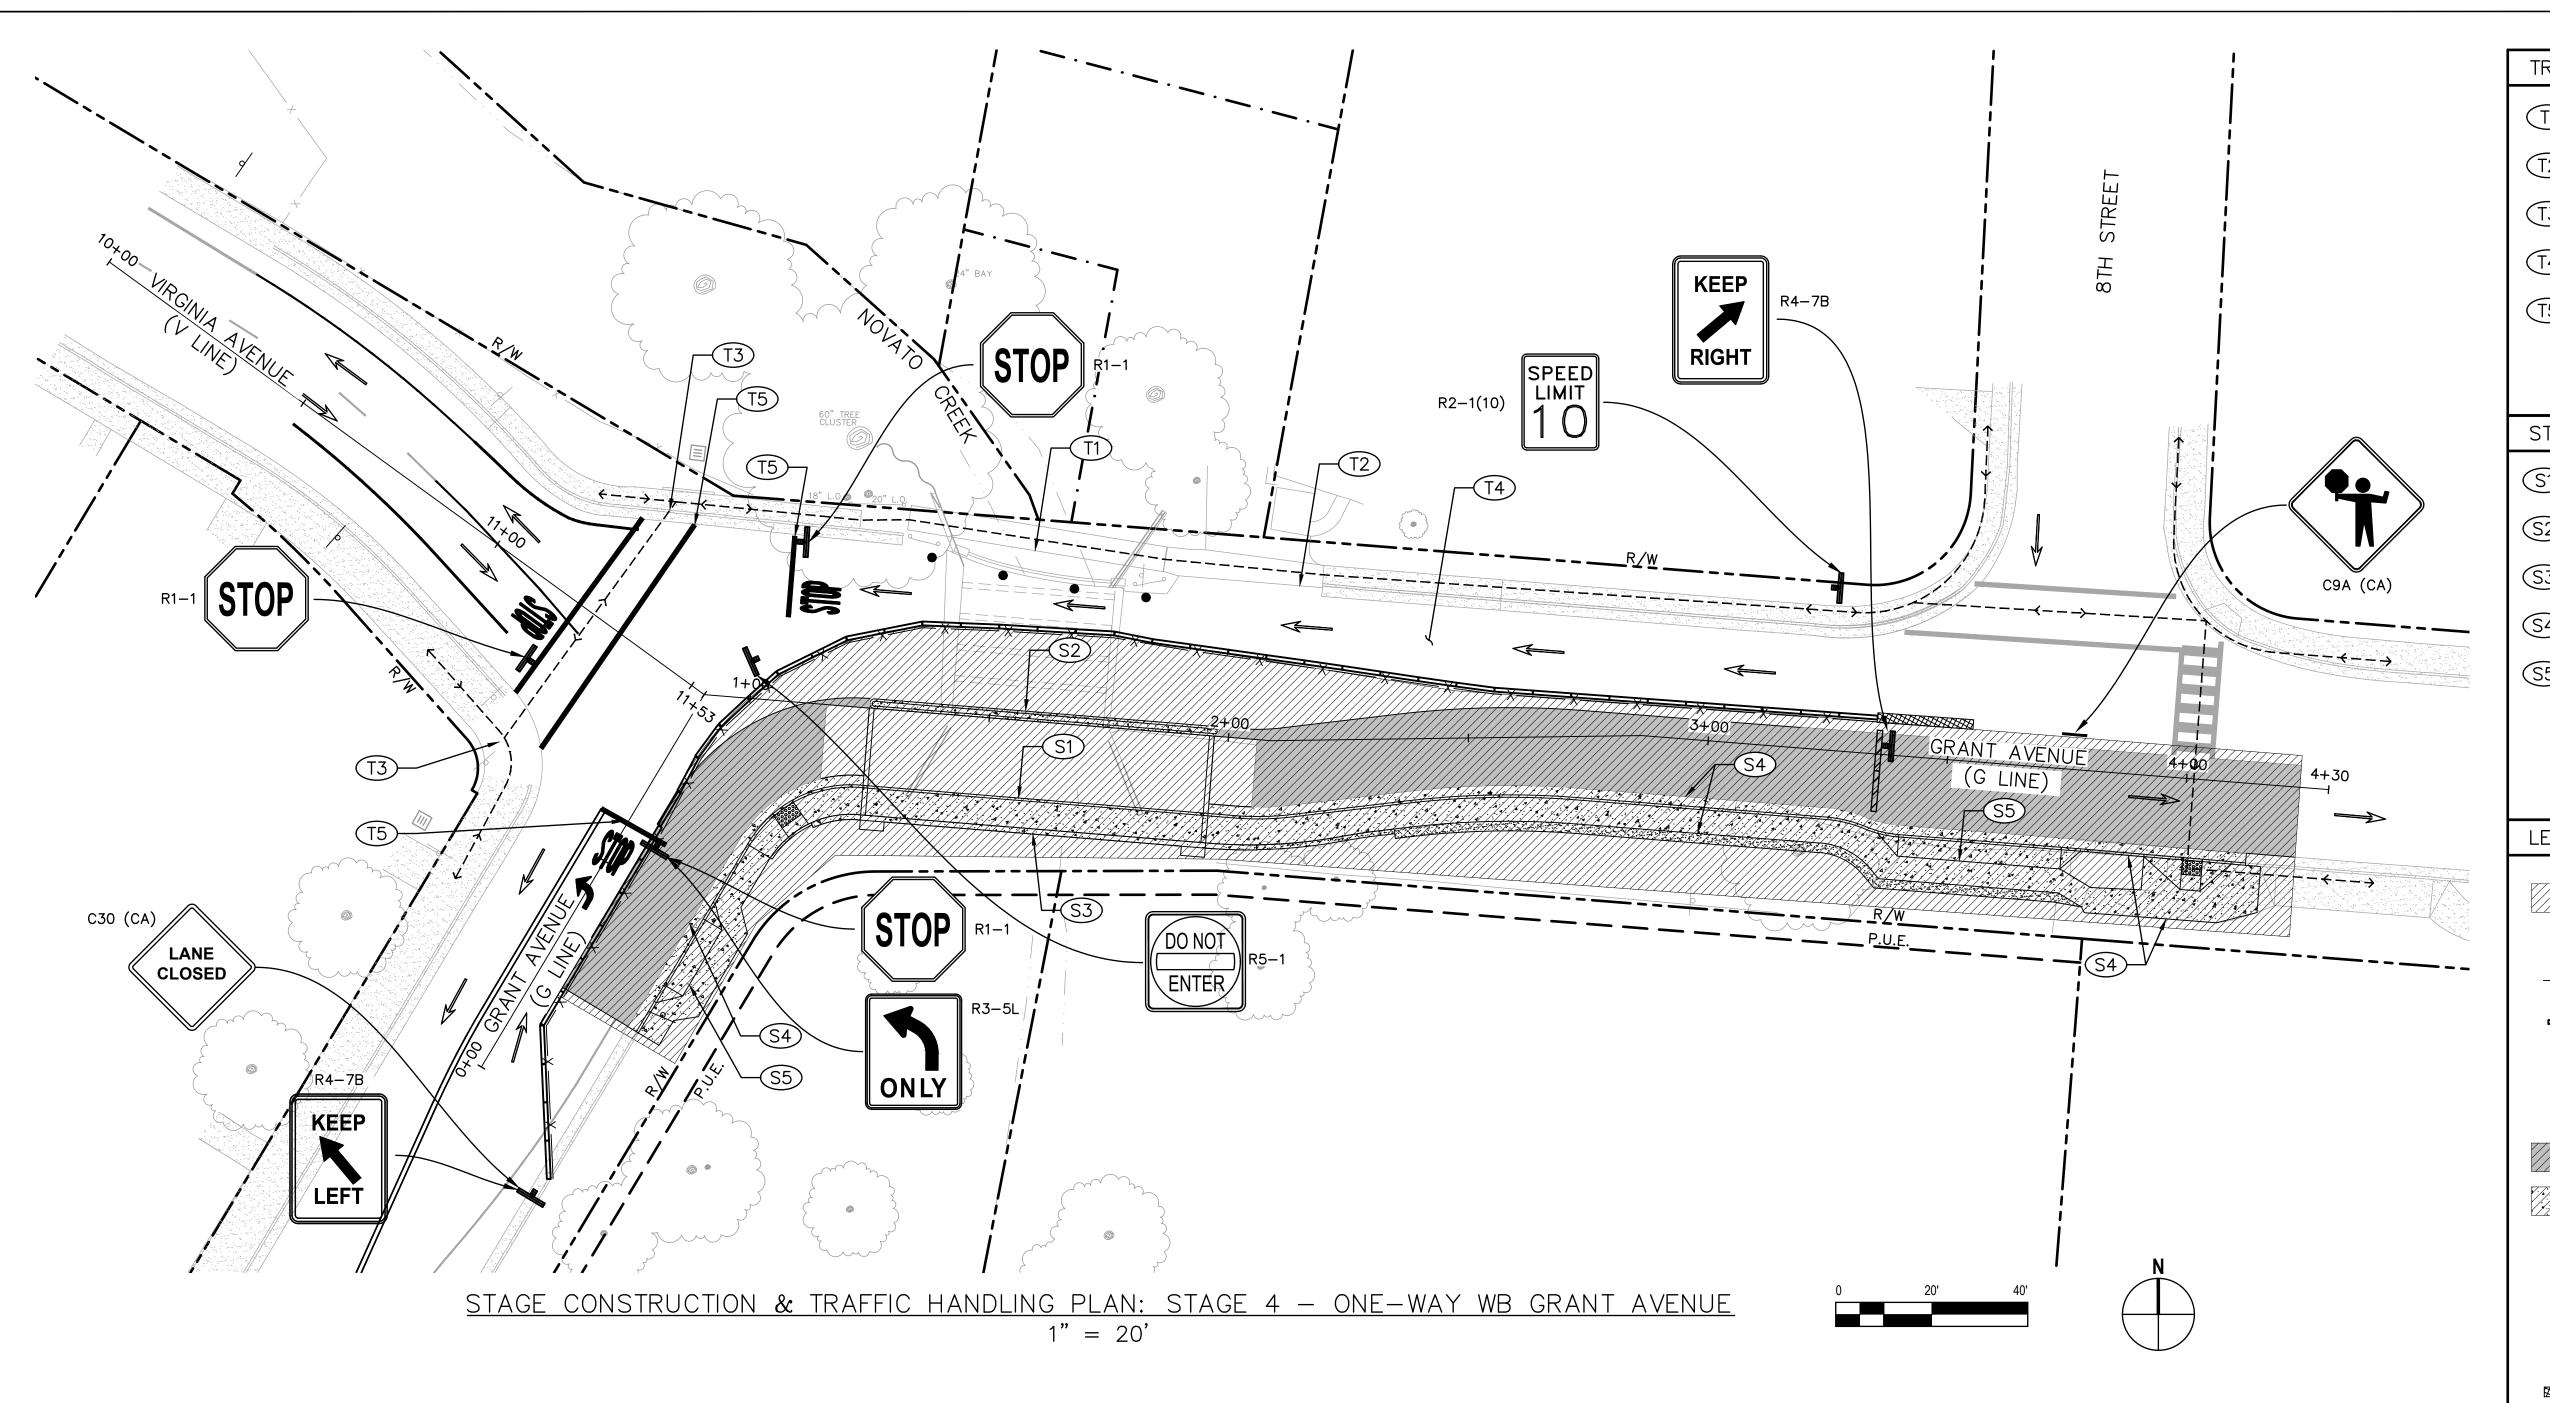


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Approved (City Engineer)		Submitted (Project Engineer)	JS			N - ST
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nt	CITY OF NOVATO
	GRANT AVENUE BRIDGE REHABILITATION (CIP 09-003)
<b>:</b>	STAGE CONSTRUCTION AND TRAFFIC HANDLIN
	PLAN - STAGE 3 - TEMPORARY CLOSURE
	44440005

Sht 16 of 47 Rev:

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# TRAFFIC HANDLING KEYNOTES

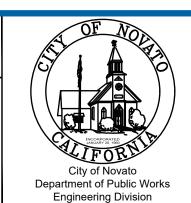- PEDESTRIAN BRIDGE TO REMAIN OPEN AND ACCESSIBLE AT ALL TIMES TO PEDESTRIANS AND BICYCLISTS
- DRIVEWAY ACCESS MUST BE MAINTAINED AT ALL TIMES
- MAINTAIN PEDESTRIAN ACCESS AND CROSSWALKS
- GRANT AVENUE ONE—WAY WESTBOUND FROM 8TH
  STREET TO VIRGINIA AVENUE, PLACE DETOUR AS SHOWN ON SHEET DE 1
- INSTALL TEMP PAVEMENT MARKING

### STAGE 4 CONSTRUCTION KEYNOTES

- CONSTRUCT BRIDGE SIDEWALK (SEE STRUCTURAL PLANS)
- CONSTRUCT BRIDGE MEDIAN (SEE STRUCTURAL PLANS)
- CONSTRUCT BRIDGE BARRIER (SEE STRUCTURAL PLANS)
- CONSTRUCT CONCRETE CURB/GUTTER AND SIDEWALK (SEE CIVIL PLANS)
- CONSTRUCT CONCRETE DRIVEWAY APPROACH (SEE CIVIL PLANS)

# LEGEND

CONSTRUCTION AREA THIS STAGE

SITE SECURITY FENCING WITH PRIVACY SCREENING

TEMP "STOP" PAVEMENT MARKING

DIRECTION OF TRAVEL

TEMP RAILING (TYPE K)

TEMP TYPE IV PAVEMENT MARKING

HMA PAVING THIS STAGE

CONCRETE FLATWORK THIS STAGE

TEMP PEDESTRIAN ROUTING

CONSTRUCTION SIGN

DELINEATOR

TEMPORARY CRASH CUSHION ABSORB 350


IN-LINE ARRAY OR APPROVED EQUAL

TYPE 3 BARRICADE 

# SHEET NOTES:

- 1. REMOVE ANY CONFLICTING STRIPING, EXISTING OR NO PARKING FROM PREVIOUS STAGE.
- 2. FOR ADDITIONAL SIGNAGE NOT SHOWN, SEE MUTCD AND DETOUR PLAN 1 ON SHEET 19.

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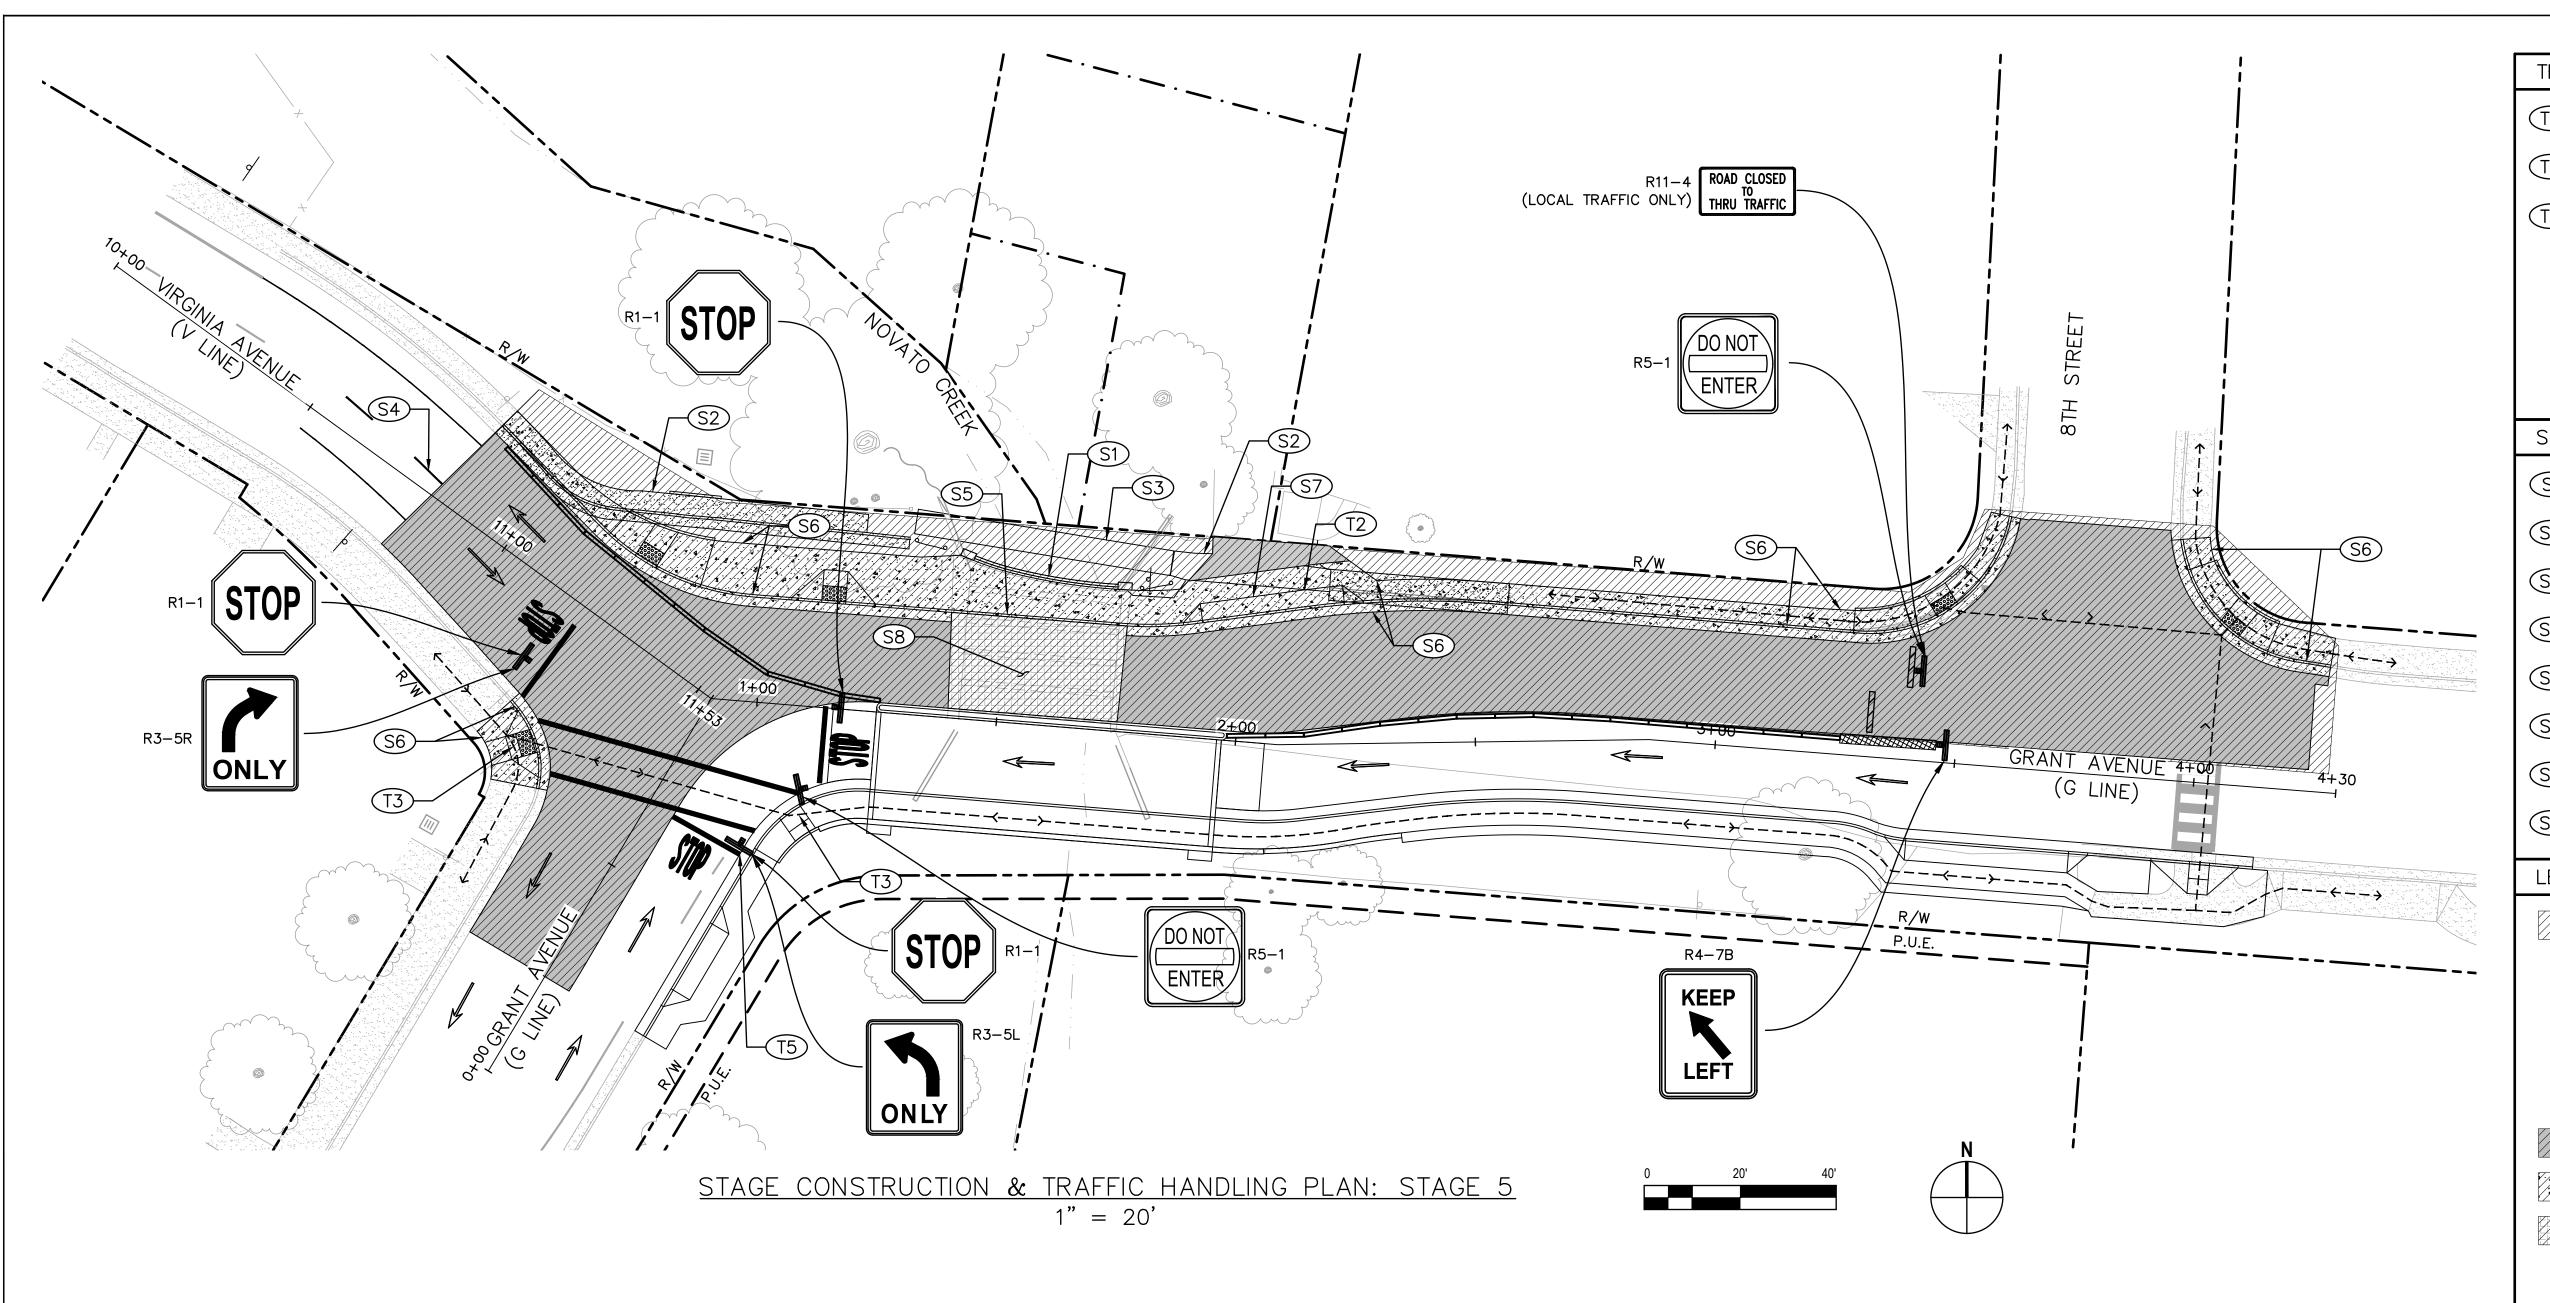


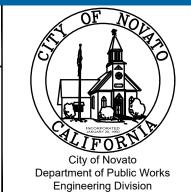

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Client CITY OF NOVATO
Project GRANT AVENUE BRIDGE REHABILITATION (CIP 09-003) STAGE CONSTRUCTION AND TRAFFIC HANDLING PLAN - STAGE 4 - ONE-WAY WB GRANT AVENUE

Sht 17 of 47 Rev:



# TRAFFIC HANDLING KEYNOTES

- T2 DRIVEWAY ACCESS MUST BE MAINTAINED AT ALL TIMES
- MAINTAIN PEDESTRIAN ACCESS AND CROSSWALKS
- INSTALL TEMP PAVEMENT MARKING

# STAGE 5 CONSTRUCTION KEYNOTES

- REMOVE EXISTING BRIDGE BARRIER/CONSTRUCT NEW BRIDGE BARRIER (SEE STRUCTURAL PLANS)
- REMOVE EXISTING SIDEWALK
- REMOVE EXISTING PEDESTRIAN BRIDGE
- REMOVE EXISTING STRIPING
- CONSTRUCT BRIDGE SIDEWALK (SEE CIVIL PLANS)
- CONSTRUCT CONCRETE CURB/GUTTER AND SIDEWALK (SEE CIVIL PLANS)
- CONSTRUCT CONCRETE DRIVEWAY APPROACH (SEE CIVIL PLANS)
- MILL AND GRIND DECK AND PLACE POLYESTER CONCRETE OVERLAY

# LEGEND

CONSTRUCTION AREA THIS STAGE DIRECTION OF TRAVEL

TEMP RAILING (TYPE K) TEMP "STOP" PAVEMENT MARKING

TEMP TYPE IV PAVEMENT MARKING HMA PAVING THIS STAGE

CONCRETE FLATWORK THIS STAGE

POLYESTER CONCRETE OVERLAY

TEMP PEDESTRIAN ROUTING

DELINEATOR

CONSTRUCTION SIGN


TEMPORARY CRASH CUSHION ABSORB 350 IN-LINE ARRAY OR APPROVED EQUAL

TYPE 3 BARRICADE

# SHEET NOTES:

- 1. REMOVE ANY CONFLICTING STRIPING, EXISTING OR NO PARKING FROM PREVIOUS STAGE.
- MAINTAIN TWO-WAY TRAFFIC, ONE-WAY FLAG CONTROL ACCEPTABLE DURING WORK HOURS.

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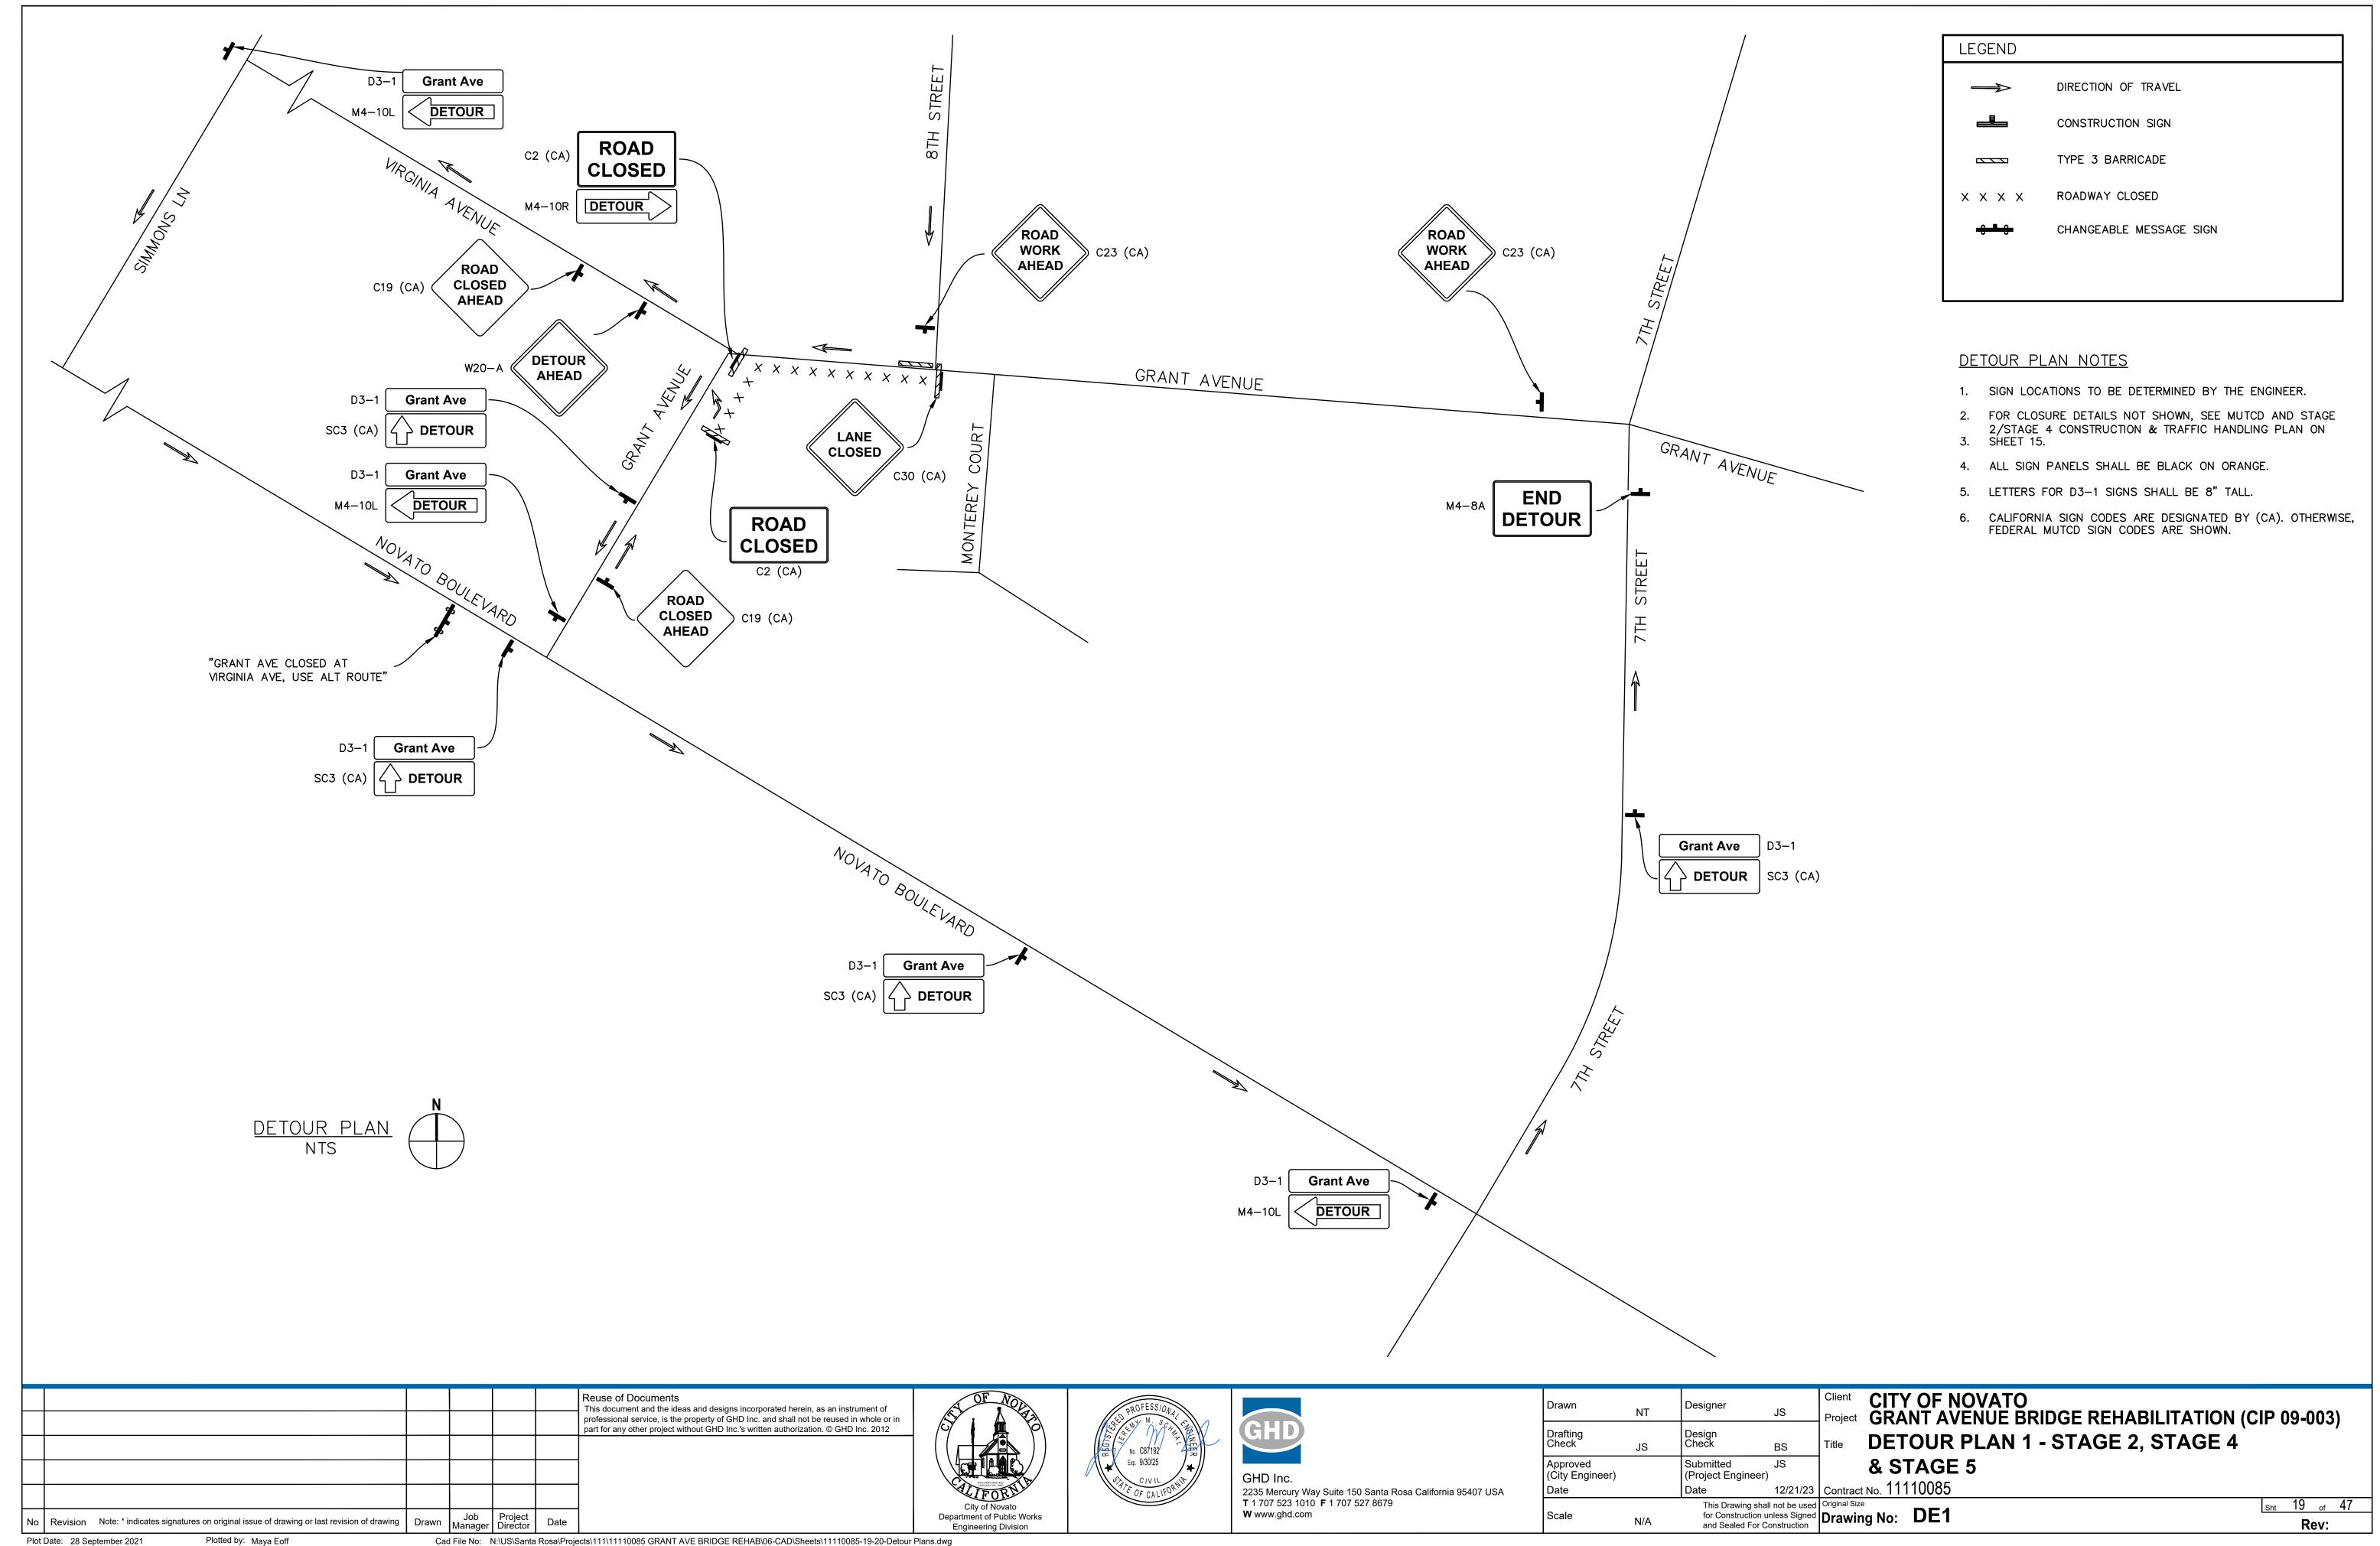
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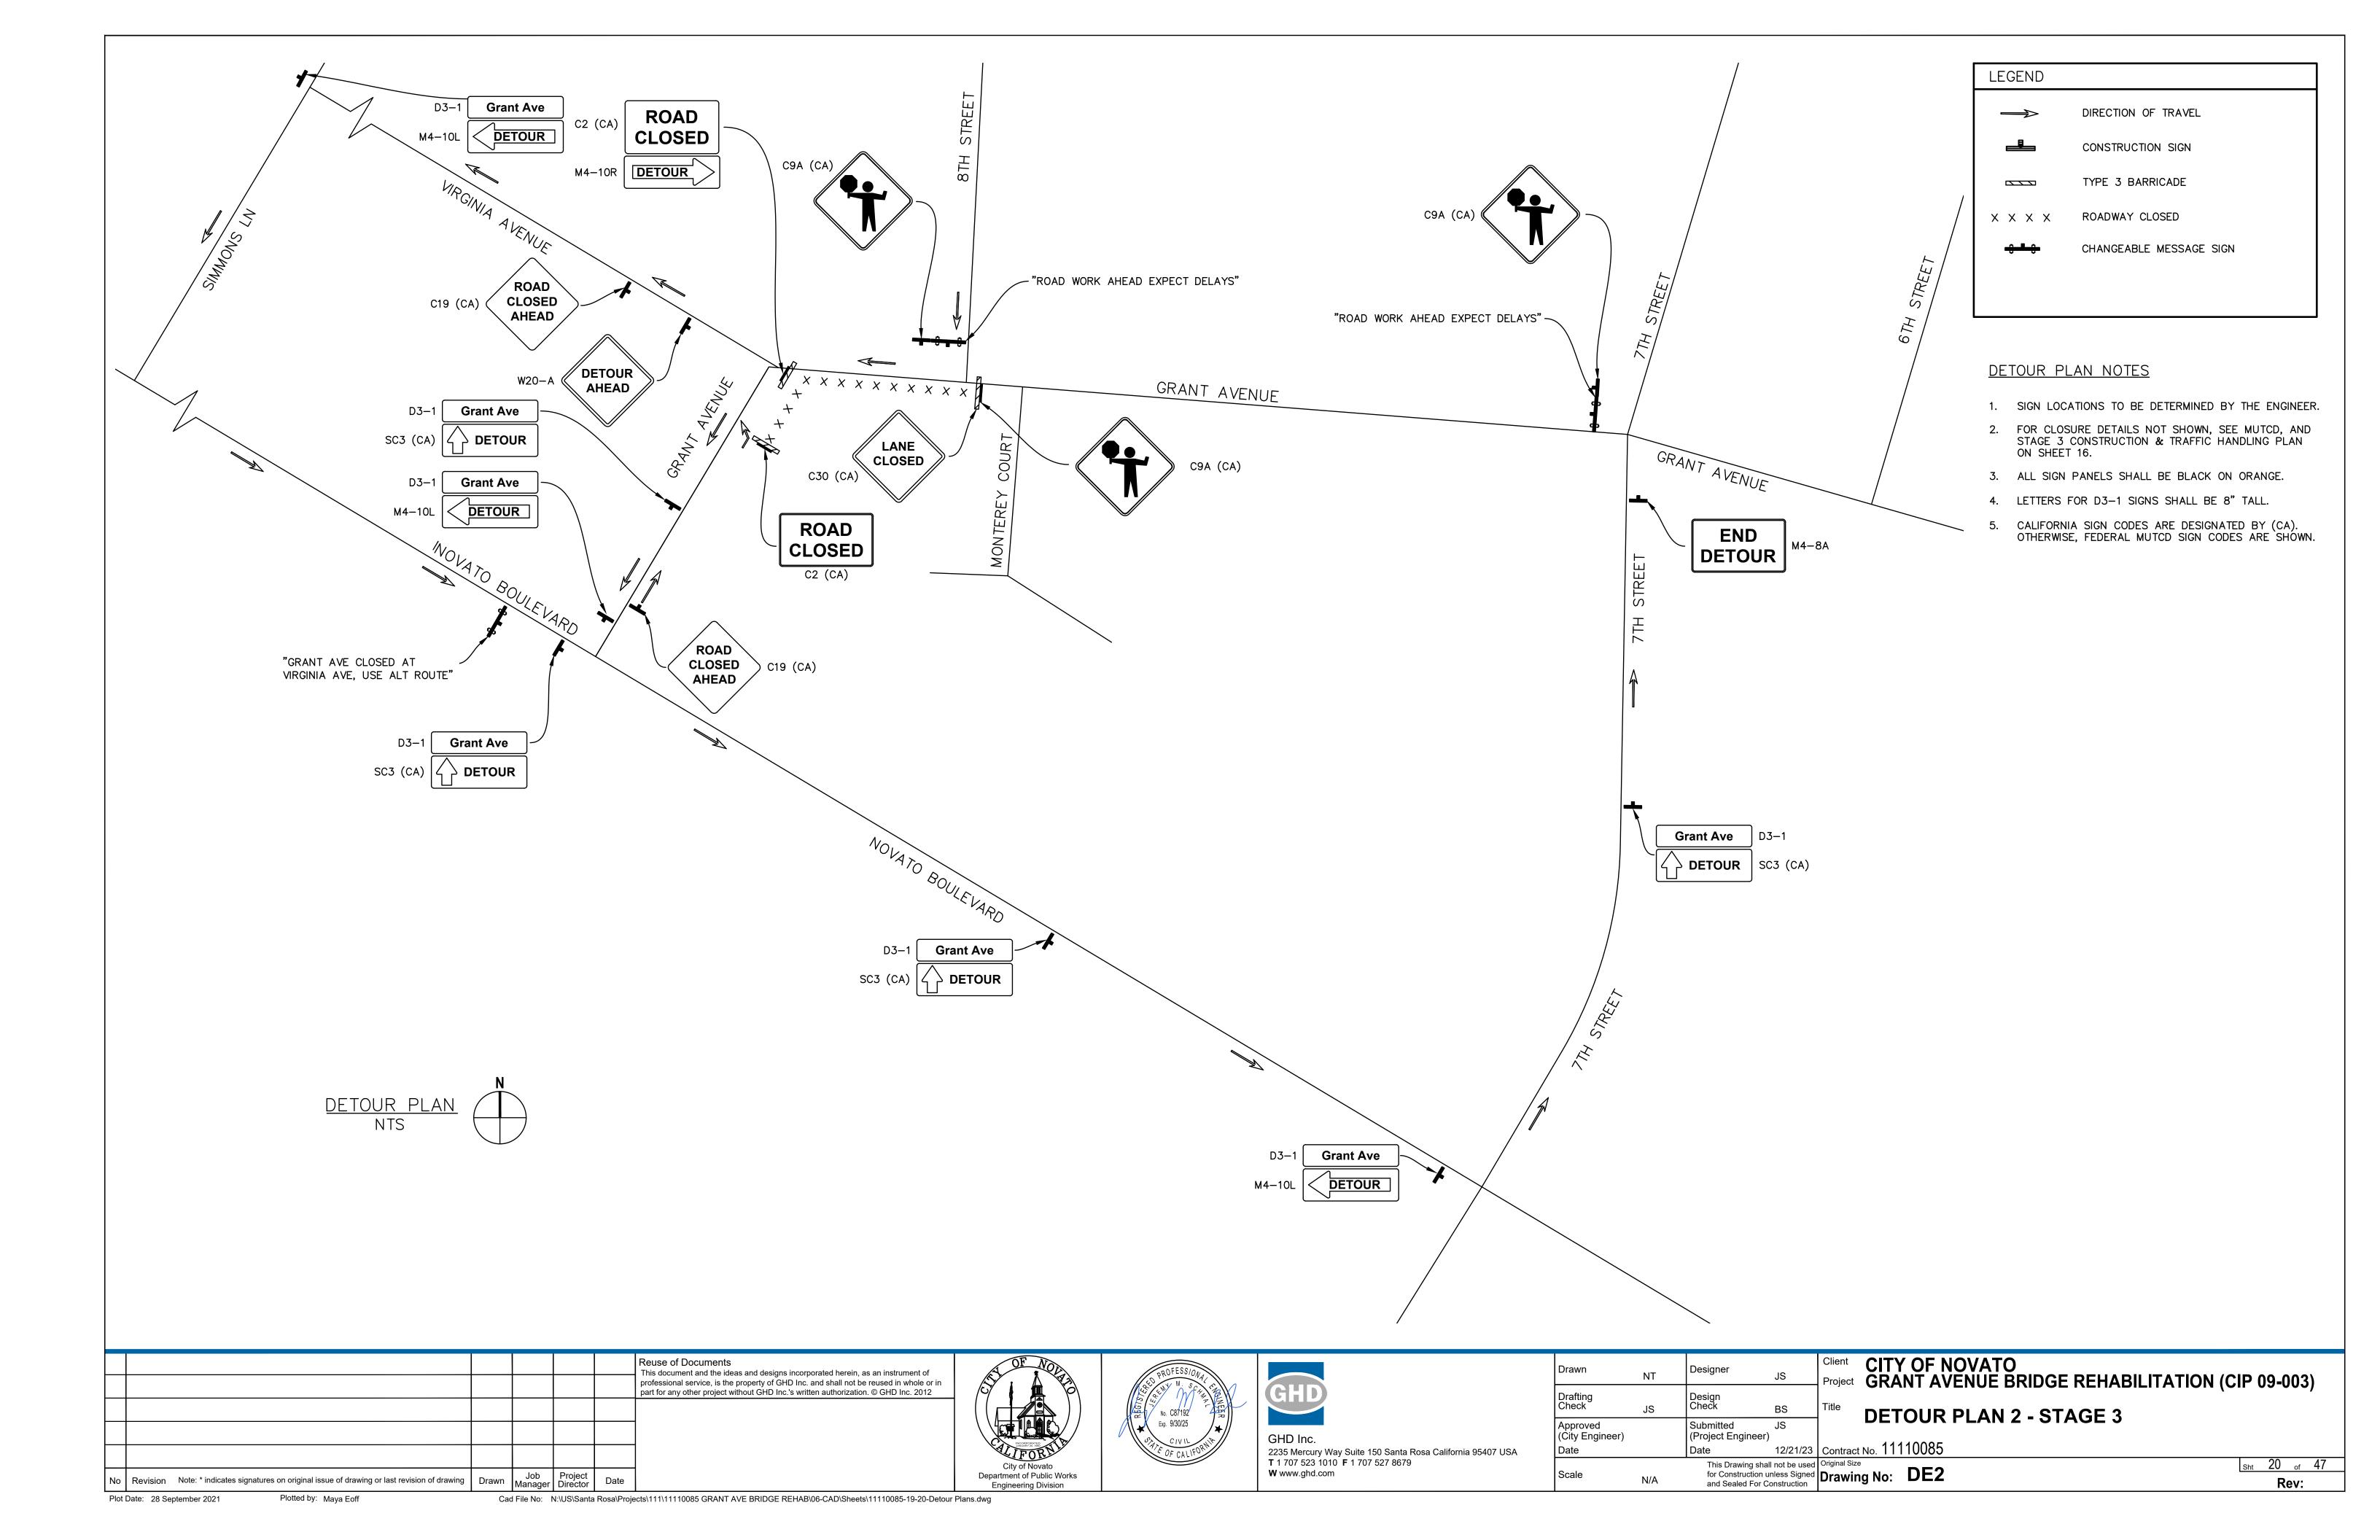
Client CITY OF NOVATO
Project GRANT AVENUE BRIDGE REHABILITATION (CIP 09-003) Title STAGE CONSTRUCTION AND TRAFFIC HANDLING **PLAN - STAGE 5 - ONE-WAY WB GRANT AVENUE** 

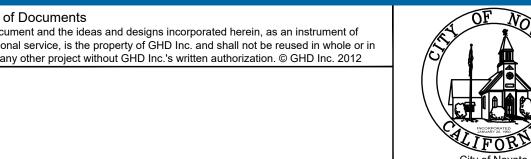
Contract No. 11110085
Original Size

Sht 18 of 47 for Construction unless Signed and Sealed For Construction

Drawing No: SC5 Rev:






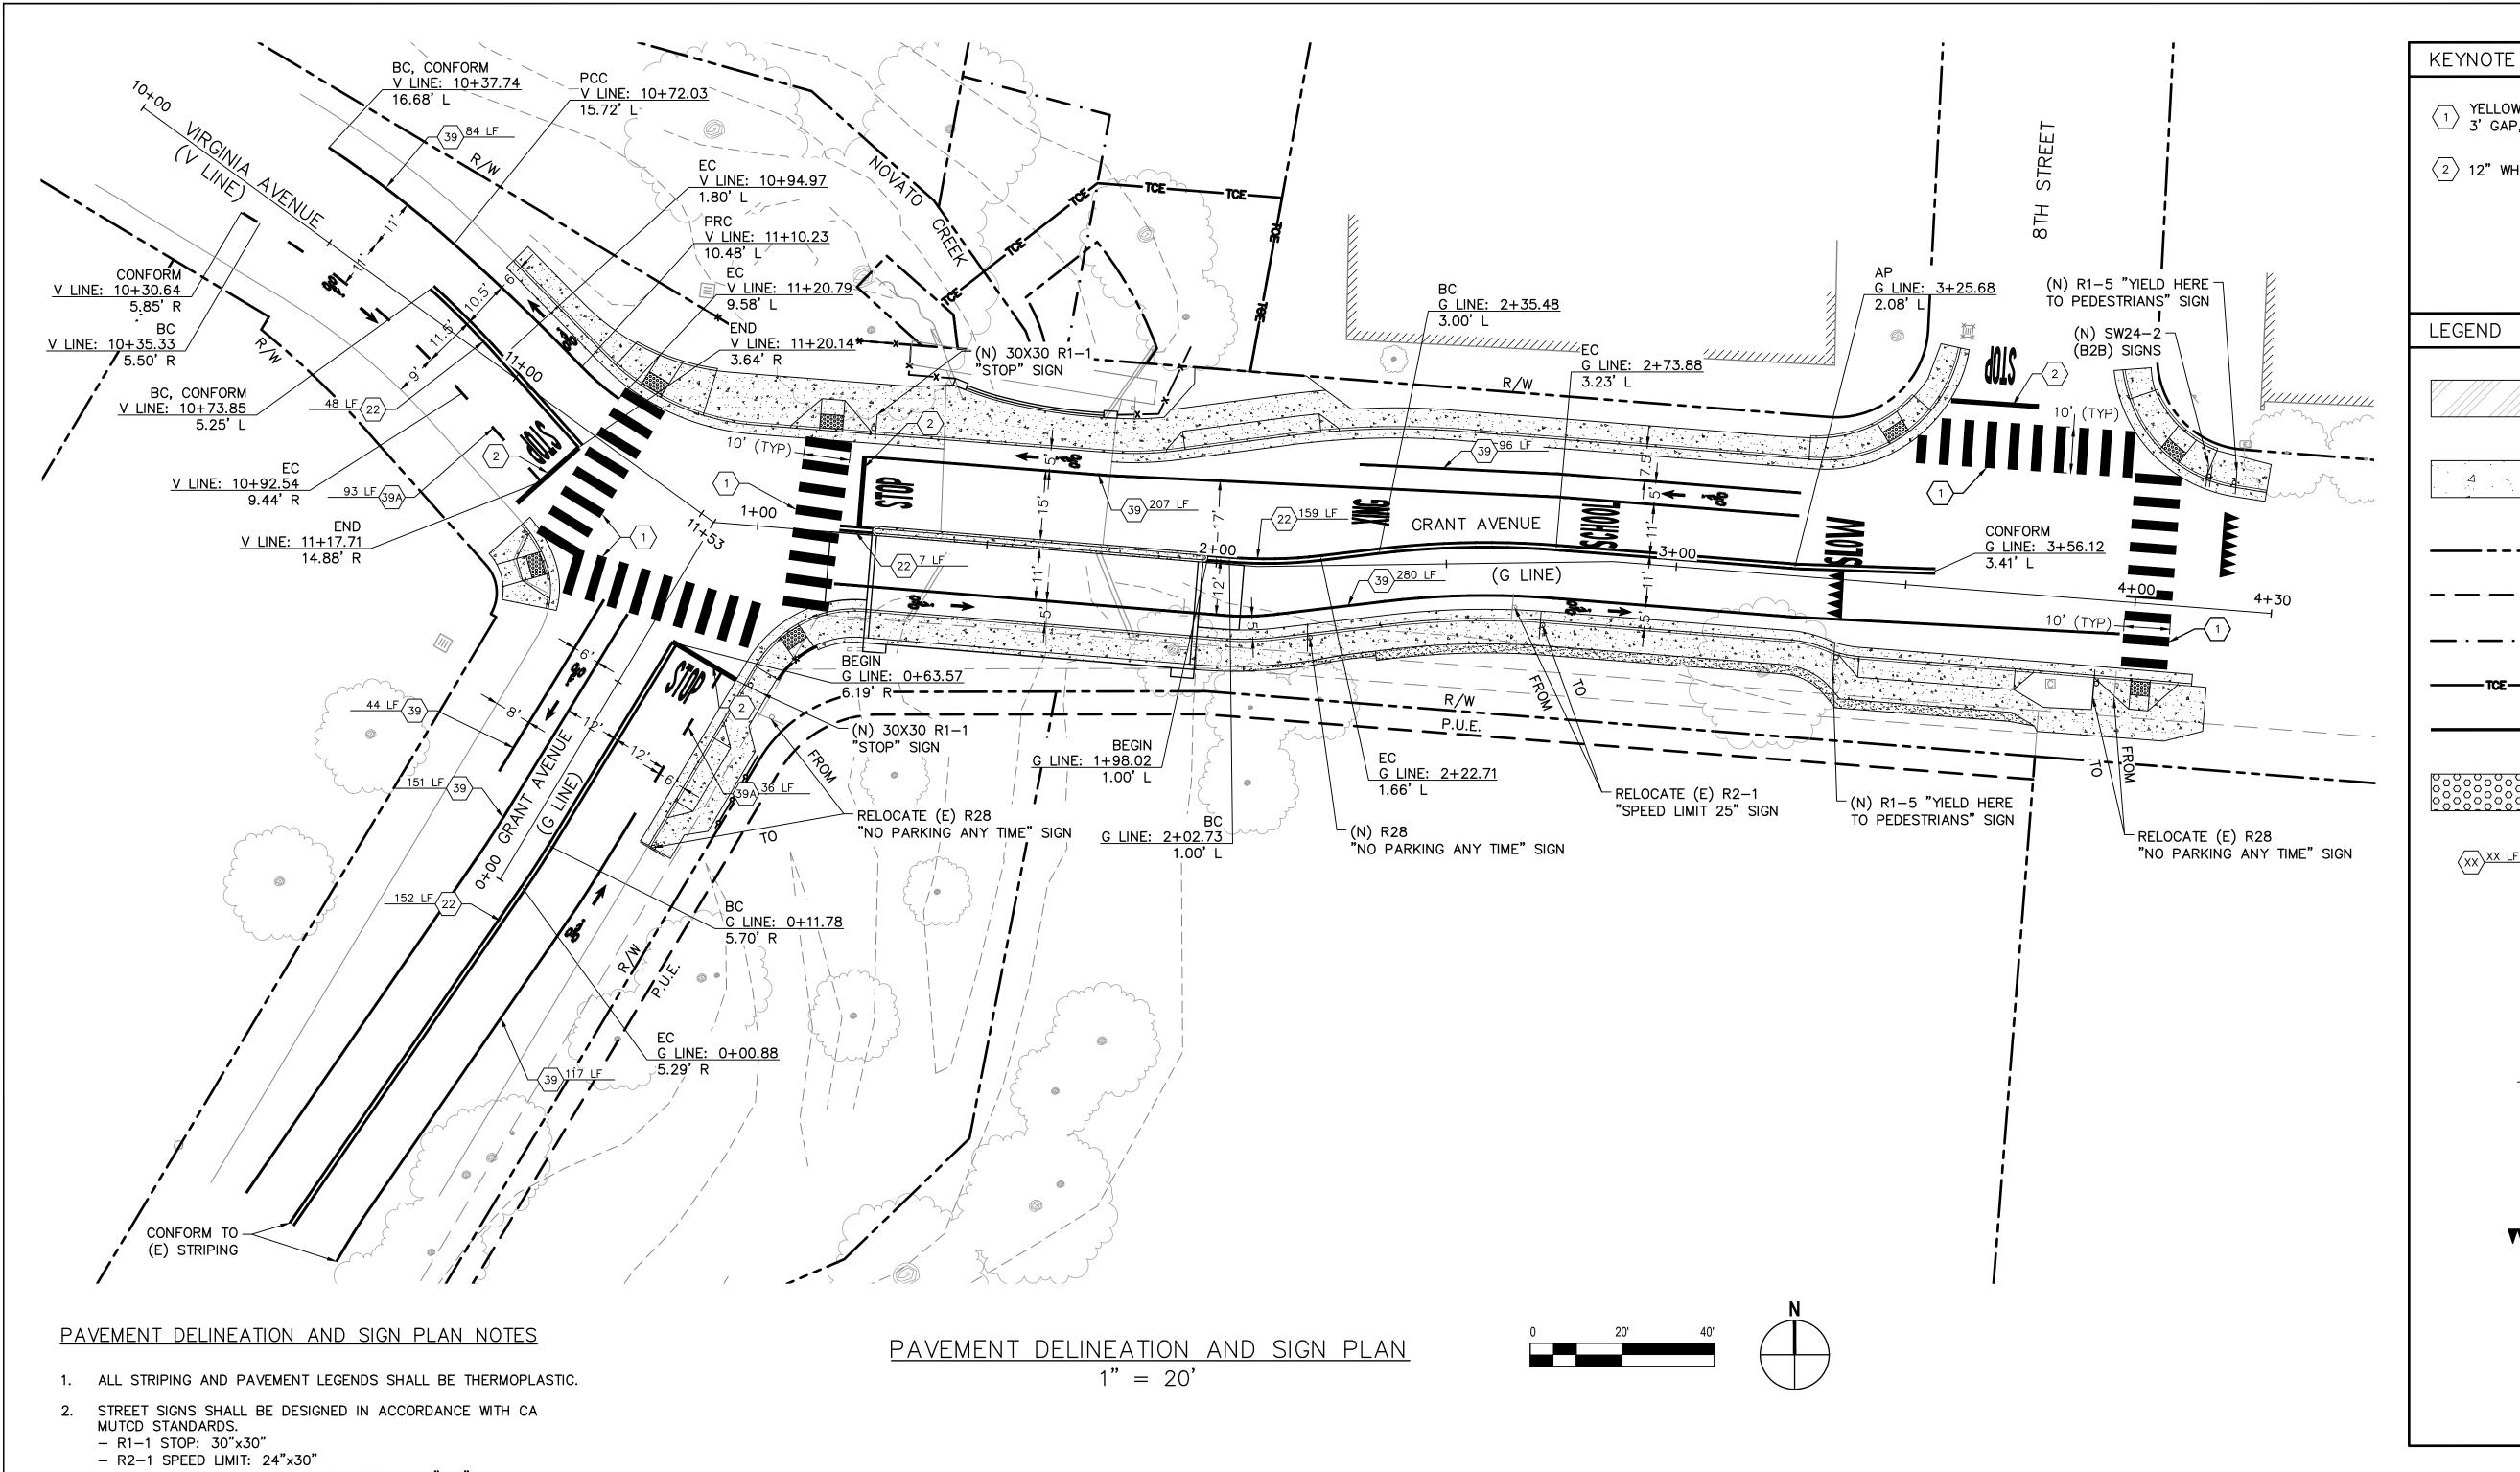


$\langle 2 \rangle$ 12" WHITE STOP BAR.	
LEGEND	
	EXISTING BRIDGE STRUCTURE
	NEW CONCRETE SIDEWALKS, CUR GUTTER AND PEDESTRIAN RAMP
	RIGHT OF WAY (R/W)
	PUBLIC UTILITY EASEMENT (PUE
	ACCESS EASEMENT
TCETCE	TEMPORARY CONSTRUCTION EASEMENT (TCE)
	TRAFFIC STRIPING
	TRUNCATED DOMES
XXX LF	STRIPING PER CALTRANS STANDARD DETAILS AND LENGTH
STOP	PAVEMENT MARKING, PER STD PLAN A24D (WHITE, UON)
olo	PAVEMENT MARKING, PER STD PLAN A24C (WHITE, UON)
	SIGN ON POST
<b>†</b>	PAVEMENT MARKING, PER STD PLAN A24A (WHITE, UON)
****	PAVEMENT MARKING, PER STD PLAN A24E (WHITE, UON)

- R28 NO PARKING ANYTIME WITH ARROW: 12"x18"
- 3. STREET SIGN POSTS SHALL BE INSTALLED PER DETAIL 1, SHEET 11 AND IN ACCORDANCE WITH UCS DWG. NO 310.
- 4. INSTALL CHANGED CONDITIONS ORANGE FLAGS ON GRANT AVENUE STOP SIGNS.
- 5. LAYOUT TO BE APPROVED PRIOR TO STRIPING.

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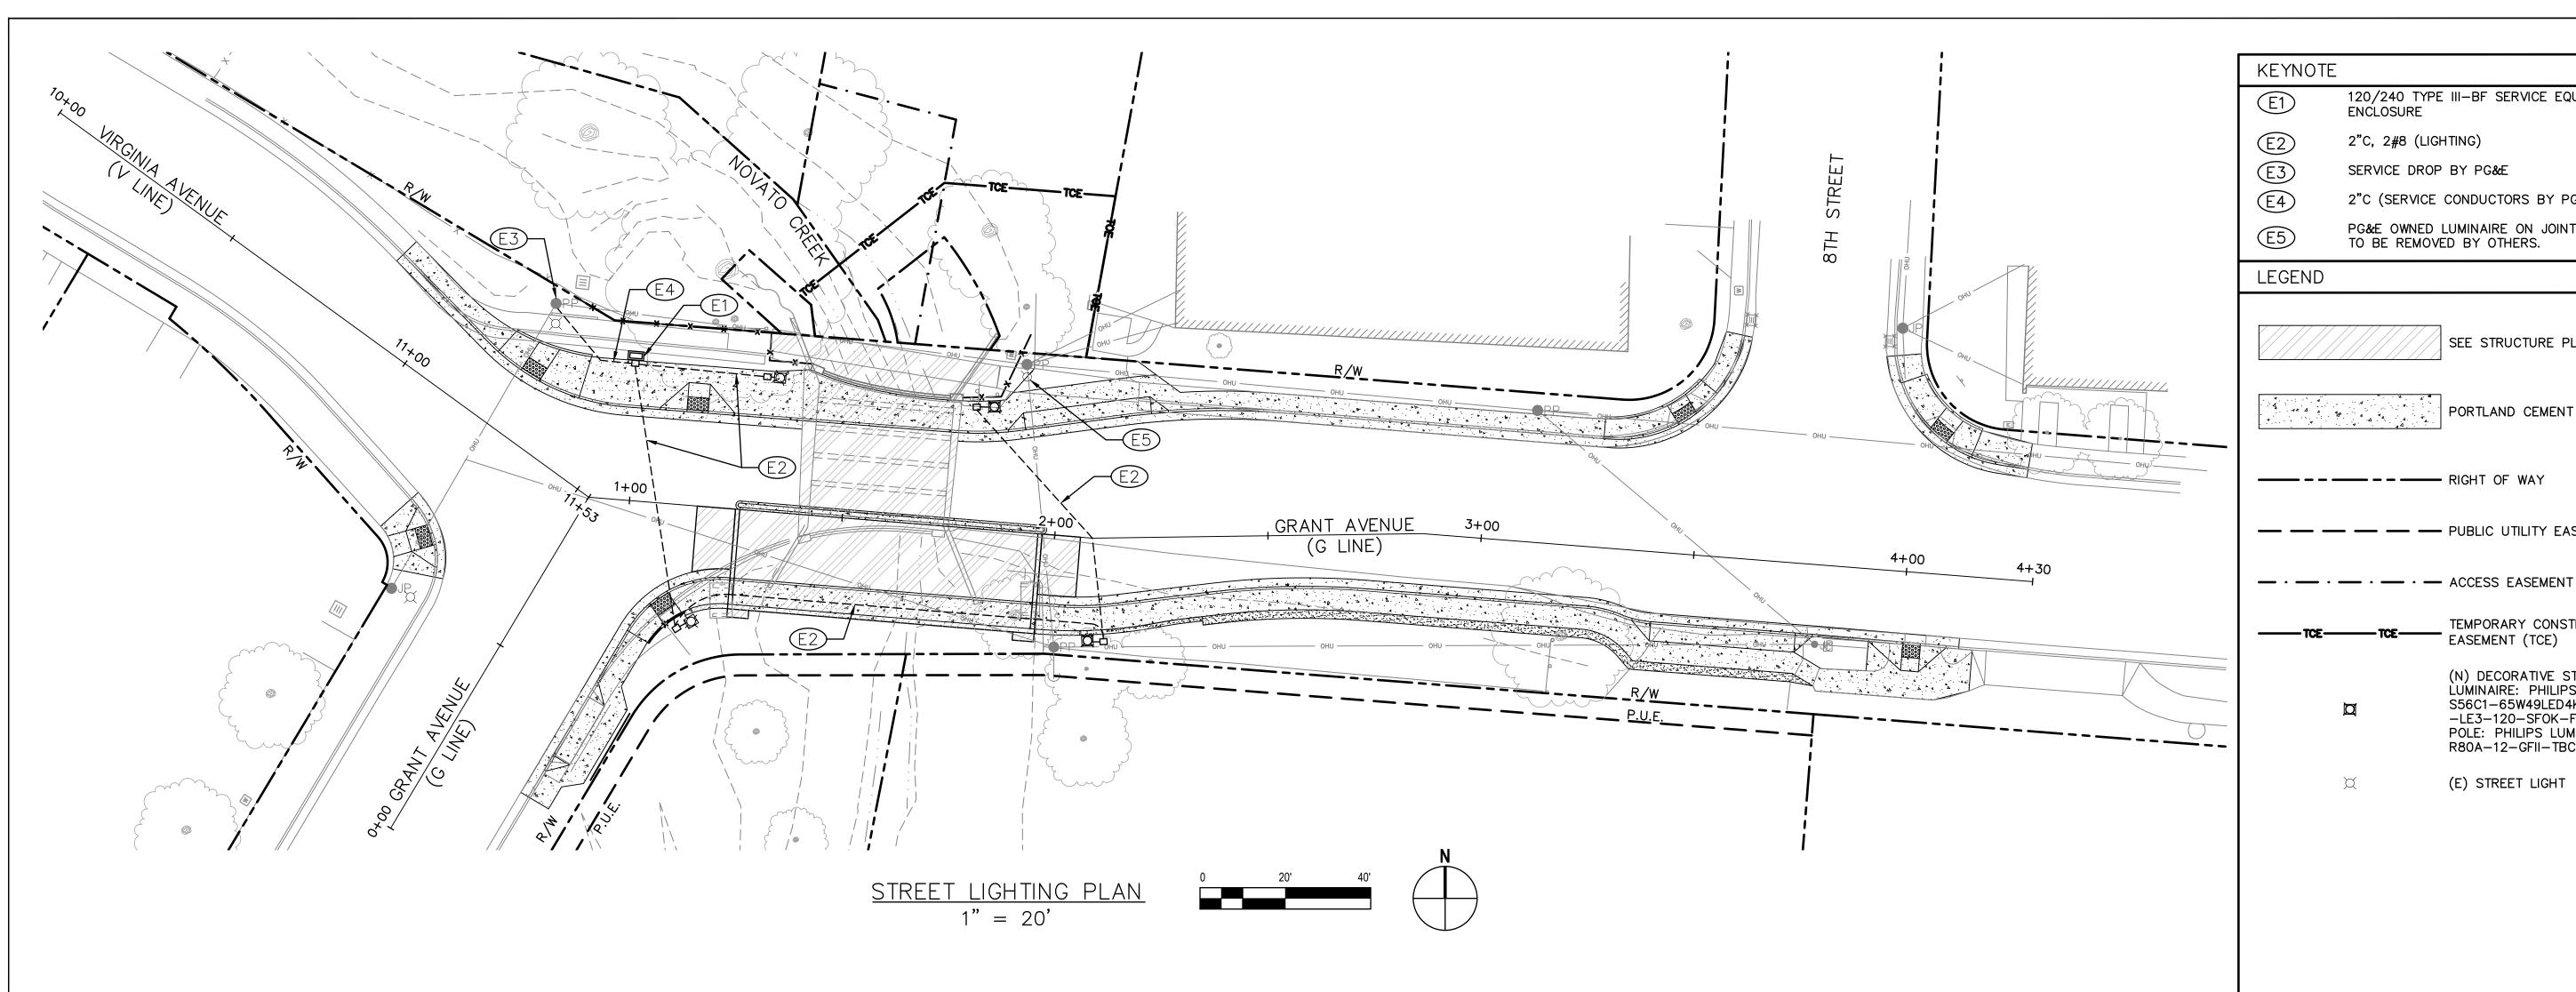
Original Size

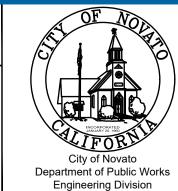Drawing No: PD1

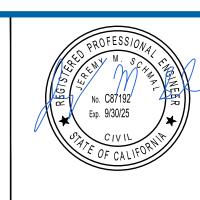CITY OF NOVATO GRANT AVENUE BRIDGE REHABILITATION (CIP 09-003) **PAVEMENT DELINEATION AND SIGN PLAN** 

12/21/23 | Contract No. 11110085


Sht 21 of 47 Rev:




# STREET LIGHTING NOTES

- LOCATION OF EXISTING UTILITIES AND STRUCTURES ARE FROM THE BEST INFORMATION AVAILABLE. EXACT LOCATION AND COMPLETENESS ARE NOT GUARANTEED. CONTRACTOR SHALL NOTIFY UNDERGROUND SERVICES ALERT (800) 227-2600 A MINIMUM OF 48 HOURS PRIOR TO ANY EXCAVATION AND POTHOLE FOR EXACT LOCATION.
- 2. SEE CALTRANS STANDARD PLANS FOR DETAILS NOT SHOWN.
- 3. ALL PULL BOXES SHALL BE No. 5 (E) UNLESS NOTED.
- 4. LOCATION OF METER PAD AND METER TO BE DETERMINED WITH PG&E.
- 5. INSTALL CONDUIT AND PULL BOXES, AS SHOWN ON PLANS, AS PART OF BID ITEM 92, LIGHTING CONDUITS AND PULL BOXES.
- 6. WORK RELATING TO ACTIVATION OF STREET LIGHTS, INCLUDING BUT NOT LIMITED TO THE PURCHASE AND INSTALLATION OF STREET LIGHT STANDARDS AND EQUIPMENT ENCLOSURE, FOUNDATIONS, DECORATIVE POLES, LUMINAIRES AND CONDUCTORS IS INCLUDED IN BID ALTERNATIVE 4, STREET LIGHT ACTIVATION.

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g	Drawn	Job Manager	Project Director	Date		Department Enginee

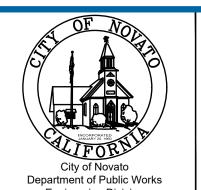



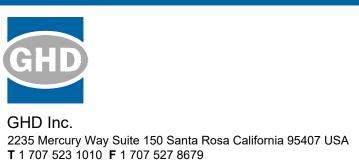

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Drafting Check	JS	Design Check	BS	Title	STR	
Approved (City Engineer)		Submitted (Project Engineer)	JS		111	1000
Date		Date	12/21/23		No. 111	1000
Scale	1" = 20'	This Drawing shall for Construction ur and Sealed For Co	nless Signed			E1

Client	CITY OF NOVATO
Project	<b>GRANT AVENUE BRIDGE REHABILITATION (CIP 09-003</b>
Title	STREET LIGHTING PLAN

Contract No. 11110085

Sht 22 of 47 Rev:

120/240 TYPE III-BF SERVICE EQUIPMENT ENCLOSURE

2"C (SERVICE CONDUCTORS BY PG&E)

PG&E OWNED LUMINAIRE ON JOINT POLE. TO BE REMOVED BY OTHERS.

— — PUBLIC UTILITY EASEMENT

EASEMENT (TCE)

(E) STREET LIGHT

SEE STRUCTURE PLANS


PORTLAND CEMENT CONCRETE

TEMPORARY CONSTRUCTION

(N) DECORATIVE STREET LIGHT
LUMINAIRE: PHILIPS LUMEC MODEL NO.
S56C1-65W49LED4K-ES-ACDR-LE3-120-SFOK-FN10-BKTX
POLE: PHILIPS LUMEC MODEL NO.
R80A-12-GFII-TBC1-BKTX

2"C, 2#8 (LIGHTING)

SERVICE DROP BY PG&E

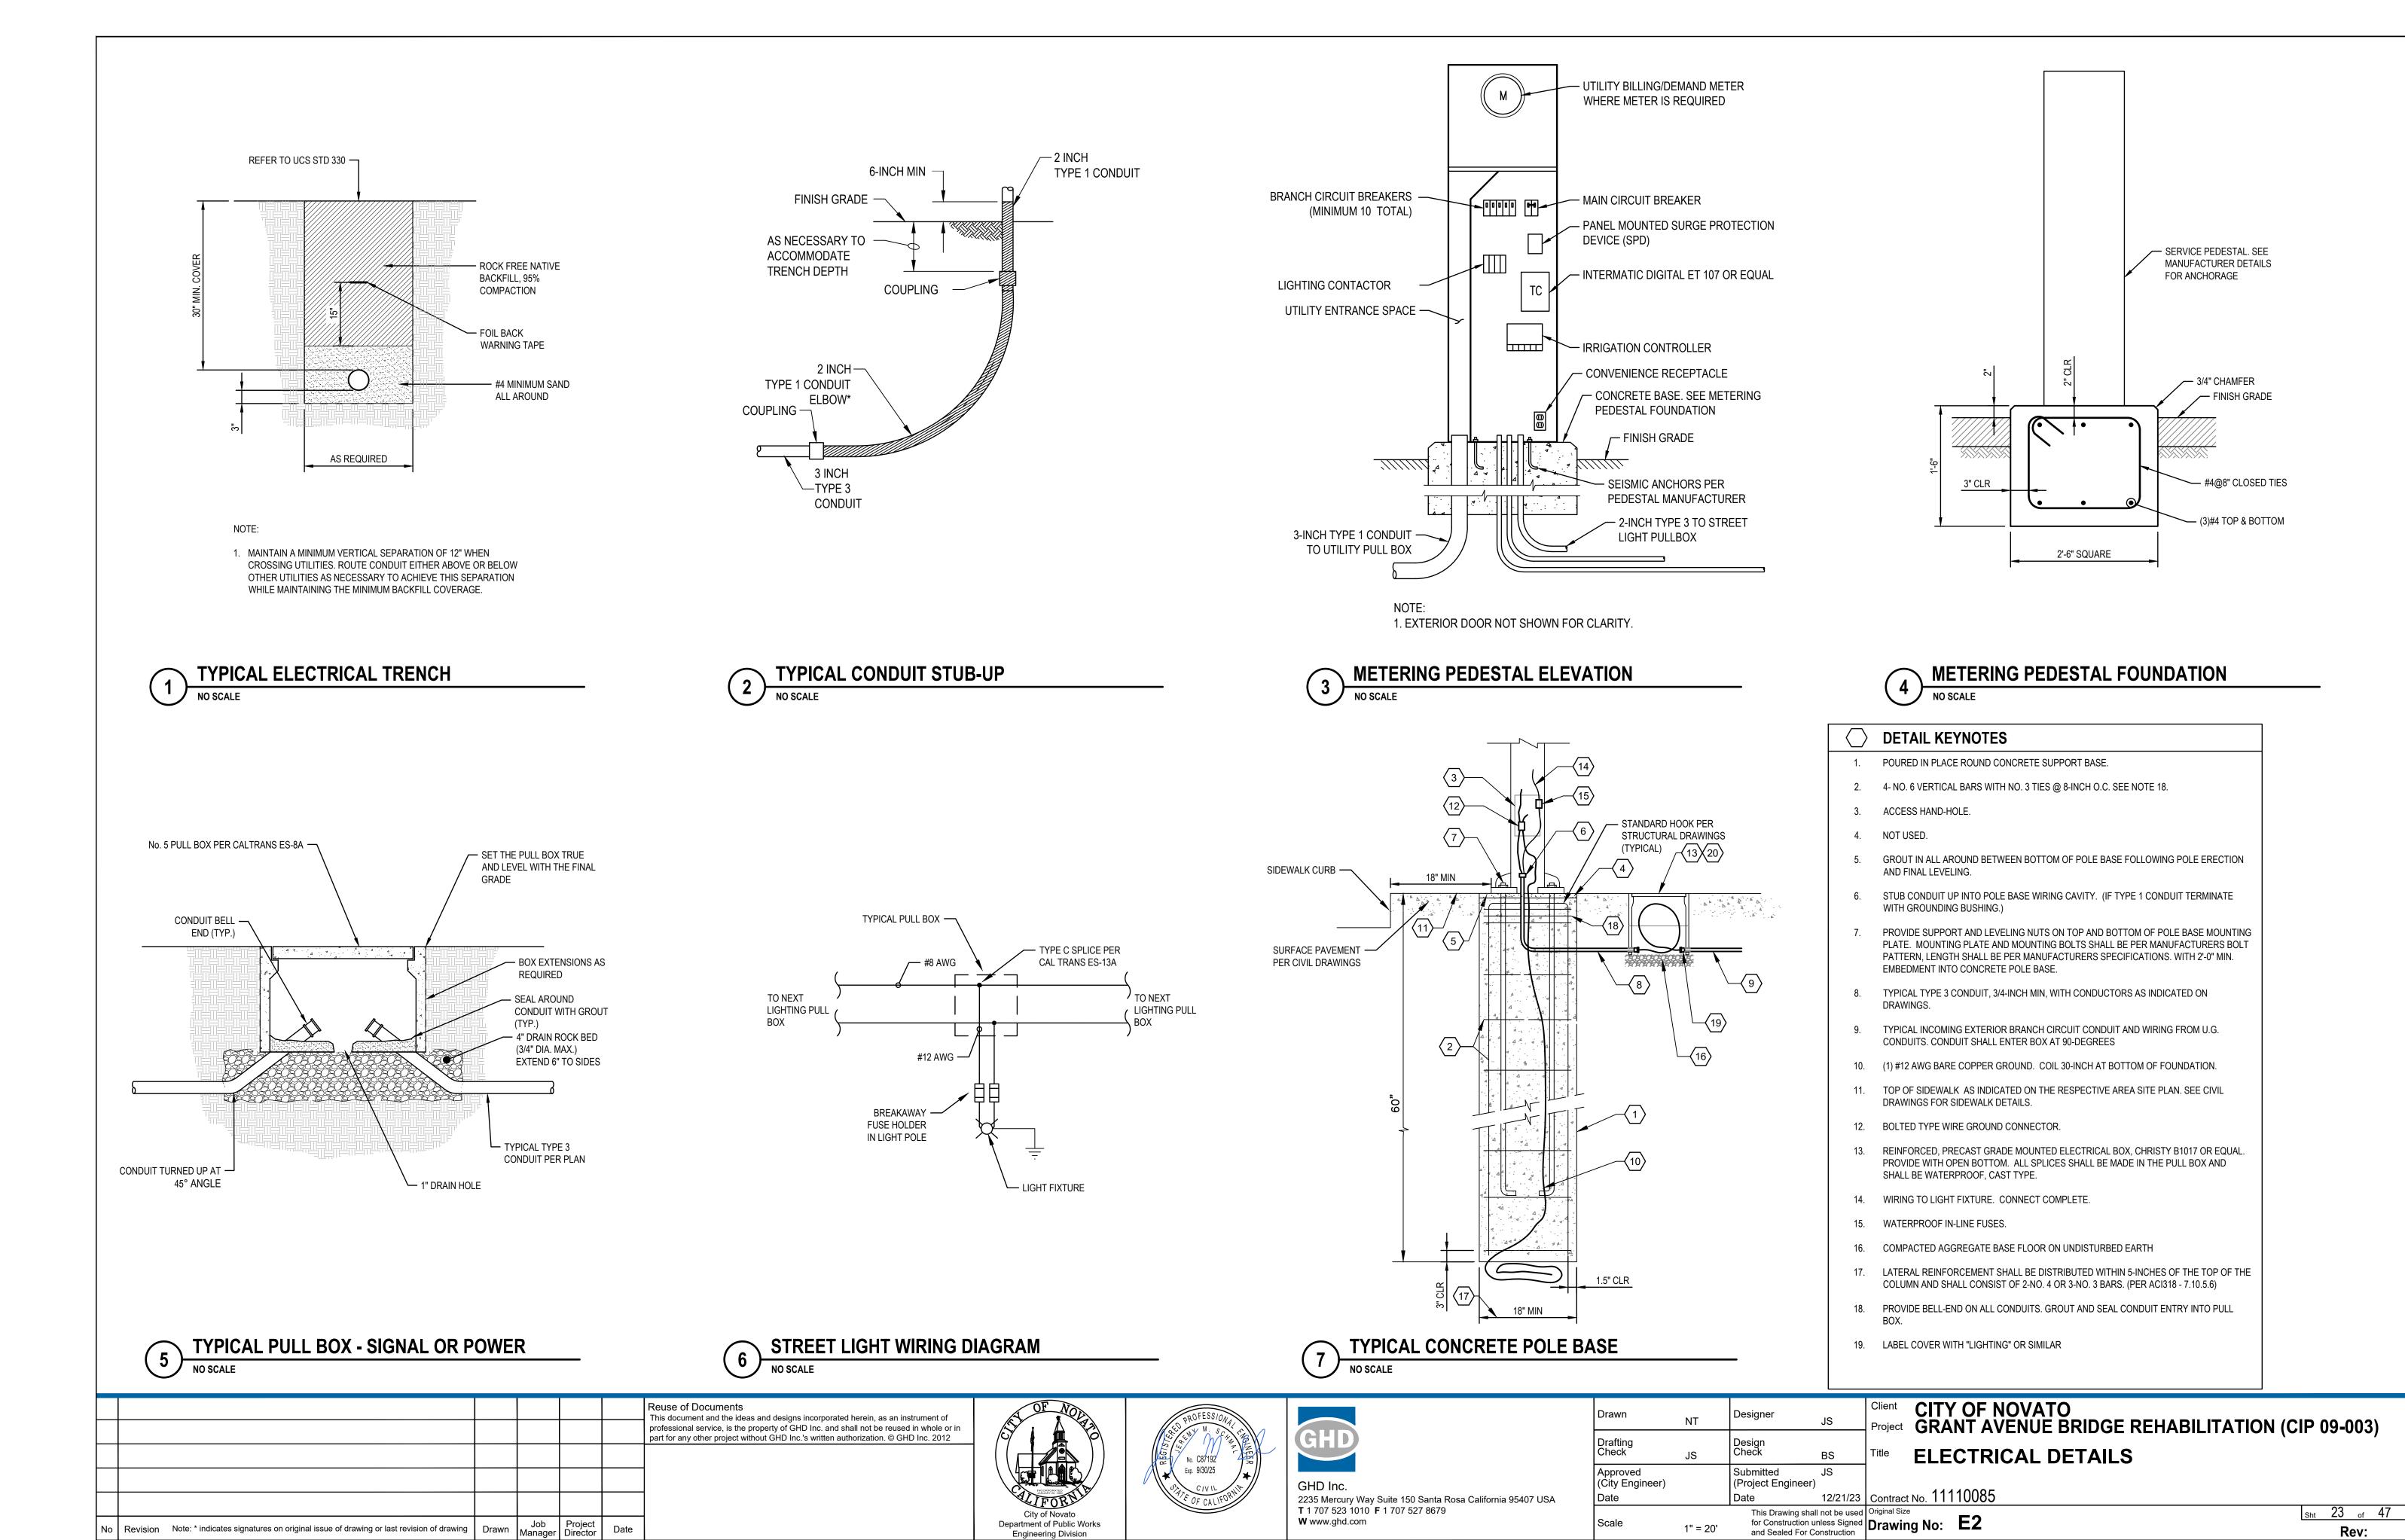



Department of Public Works


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EROSION CONTROL PLAN NOTES

# **GENERAL:**

- 1. ALL GRADING WORK SHALL BE PROTECTED BY SILT FENCING IN A MANNER TO MINIMIZE EROSION AND COLLECT SEDIMENT.
- 2. EROSION CONTROL MEASURES TO BE EMPLOYED PER CITY OF NOVATO REQUIREMENTS.
- 3. ALL EROSION CONTROL MEASURES SHALL BE MAINTAINED UNTIL DISTURBED AREAS ARE STABILIZED. CHANGES TO THIS PLAN TO MEET FIELD CONDITIONS WILL BE MADE ONLY WITH THE APPROVAL OF, OR AT THE DIRECTION OF THE OWNER. CHANGES MADE TO SUIT FIELD CONDITIONS WILL BE MADE ONLY WITH THE APPROVAL OF OR AT THE DIRECTION OF THE OWNER. CHANGES MADE TO SUIT FIELD CONDITIONS SHALL BE BROUGHT TO THE IMMEDIATE ATTENTION OF THE ENGINEER AND OWNER.
- 4. ALL EROSION CONTROL FACILITIES MUST BE INSPECTED AND REPAIRED AT THE END OF EACH WORKING DAY.
- 5. IF SIGNIFICANT SEDIMENT OR OTHER VISUAL SYMPTOMS OF IMPURITIES ARE NOTICED IN THE STORM WATER, CONTACT THE ENGINEER IMMEDIATELY.
- 6. CONTRACTOR IS RESPONSIBLE FOR INSPECTION AND RESTORATION OF ALL ASPECTS OF THE EROSION & SEDIMENTATION CONTROL PLAN. SEDIMENT ON THE SIDEWALKS AND GUTTERS SHALL BE REMOVED BY SHOVEL OR BROOM AND DISPOSED APPROPRIATELY.
- 7. ALL EMPLOYEES, CONTRACTORS, AND SUBCONTRACTORS ARE RESPONSIBLE FOR CONFORMING TO THE ELEMENTS SHOWN ON THIS PLAN OR RELATED DOCUMENTS.
- 8. CONTRACTOR TO EMPLOY BEST MANAGEMENT PRACTICES (BMP'S) IN ACCORDANCE WITH THE CITY OF NOVATO.
- 9. ALL DUMPSTERS OR OTHER TRASH STORAGE ENCLOSURES SHALL BE UTILIZED SOLELY FOR NON-HAZARDOUS MATERIALS.
- 10. ALL PAVED AREAS WILL BE KEPT CLEAR OF EARTH MATERIAL AND DEBRIS AND THE SITE SHALL BE MAINTAINED SO THAT A MINIMUM OF SEDIMENT-LADEN RUNOFF ENTERS THE STORM DRAIN SYSTEM. THESE PLANS SHALL REMAIN IN EFFECT UNTIL THE IMPROVEMENTS ARE ACCEPTED AND ALL SLOPES ARE STABILIZED.
- 11. BORROW AREAS AND TEMPORARY STOCKPILES SHALL BE PROTECTED WITH APPROPRIATE EROSION CONTROL MEASURES.
- 12. REMOVE SPOILS PROMPTLY AND AVOID STOCKPILING OF FILL MATERIALS WHEN RAIN IS FORECAST. IF RAIN IS FORECAST OR APPARENT, STOCKPILED SOILS AND OTHER MATERIALS SHALL BE COVERED WITH PLASTIC OR A TARP.
- 13. STORE, HANDLE AND DISPOSE OF CONSTRUCTION MATERIALS AND WASTES SO AS TO PREVENT THEIR ENTRY INTO THE STORM DRAIN SYSTEM. CONTRACTOR MUST NOT ALLOW CONCRETE, WASHWATERS, SLURRIES, PAINT OR OTHER MATERIALS TO ENTER THE CATCH BASINS, STORM DRAINAGE, OR ENTER SITE RUNOFF.
- 14. USE FILTRATION OR OTHER APPROVED MEASURES TO REMOVE SEDIMENT FROM DEWATERING EFFLUENT.
- 15. NO CLEANING, FUELING OR MAINTAINING VEHICLES ON SITE SHALL BE PERMITTED. DO NOT ALLOW DELETERIOUS MATERIALS TO ENTER THE CATCH BASINS, STORM DRAINAGE, OR TO ENTER SITE RUNOFF. ALL CONCRETE WASHOUT SHALL OCCUR OFF-SITE.
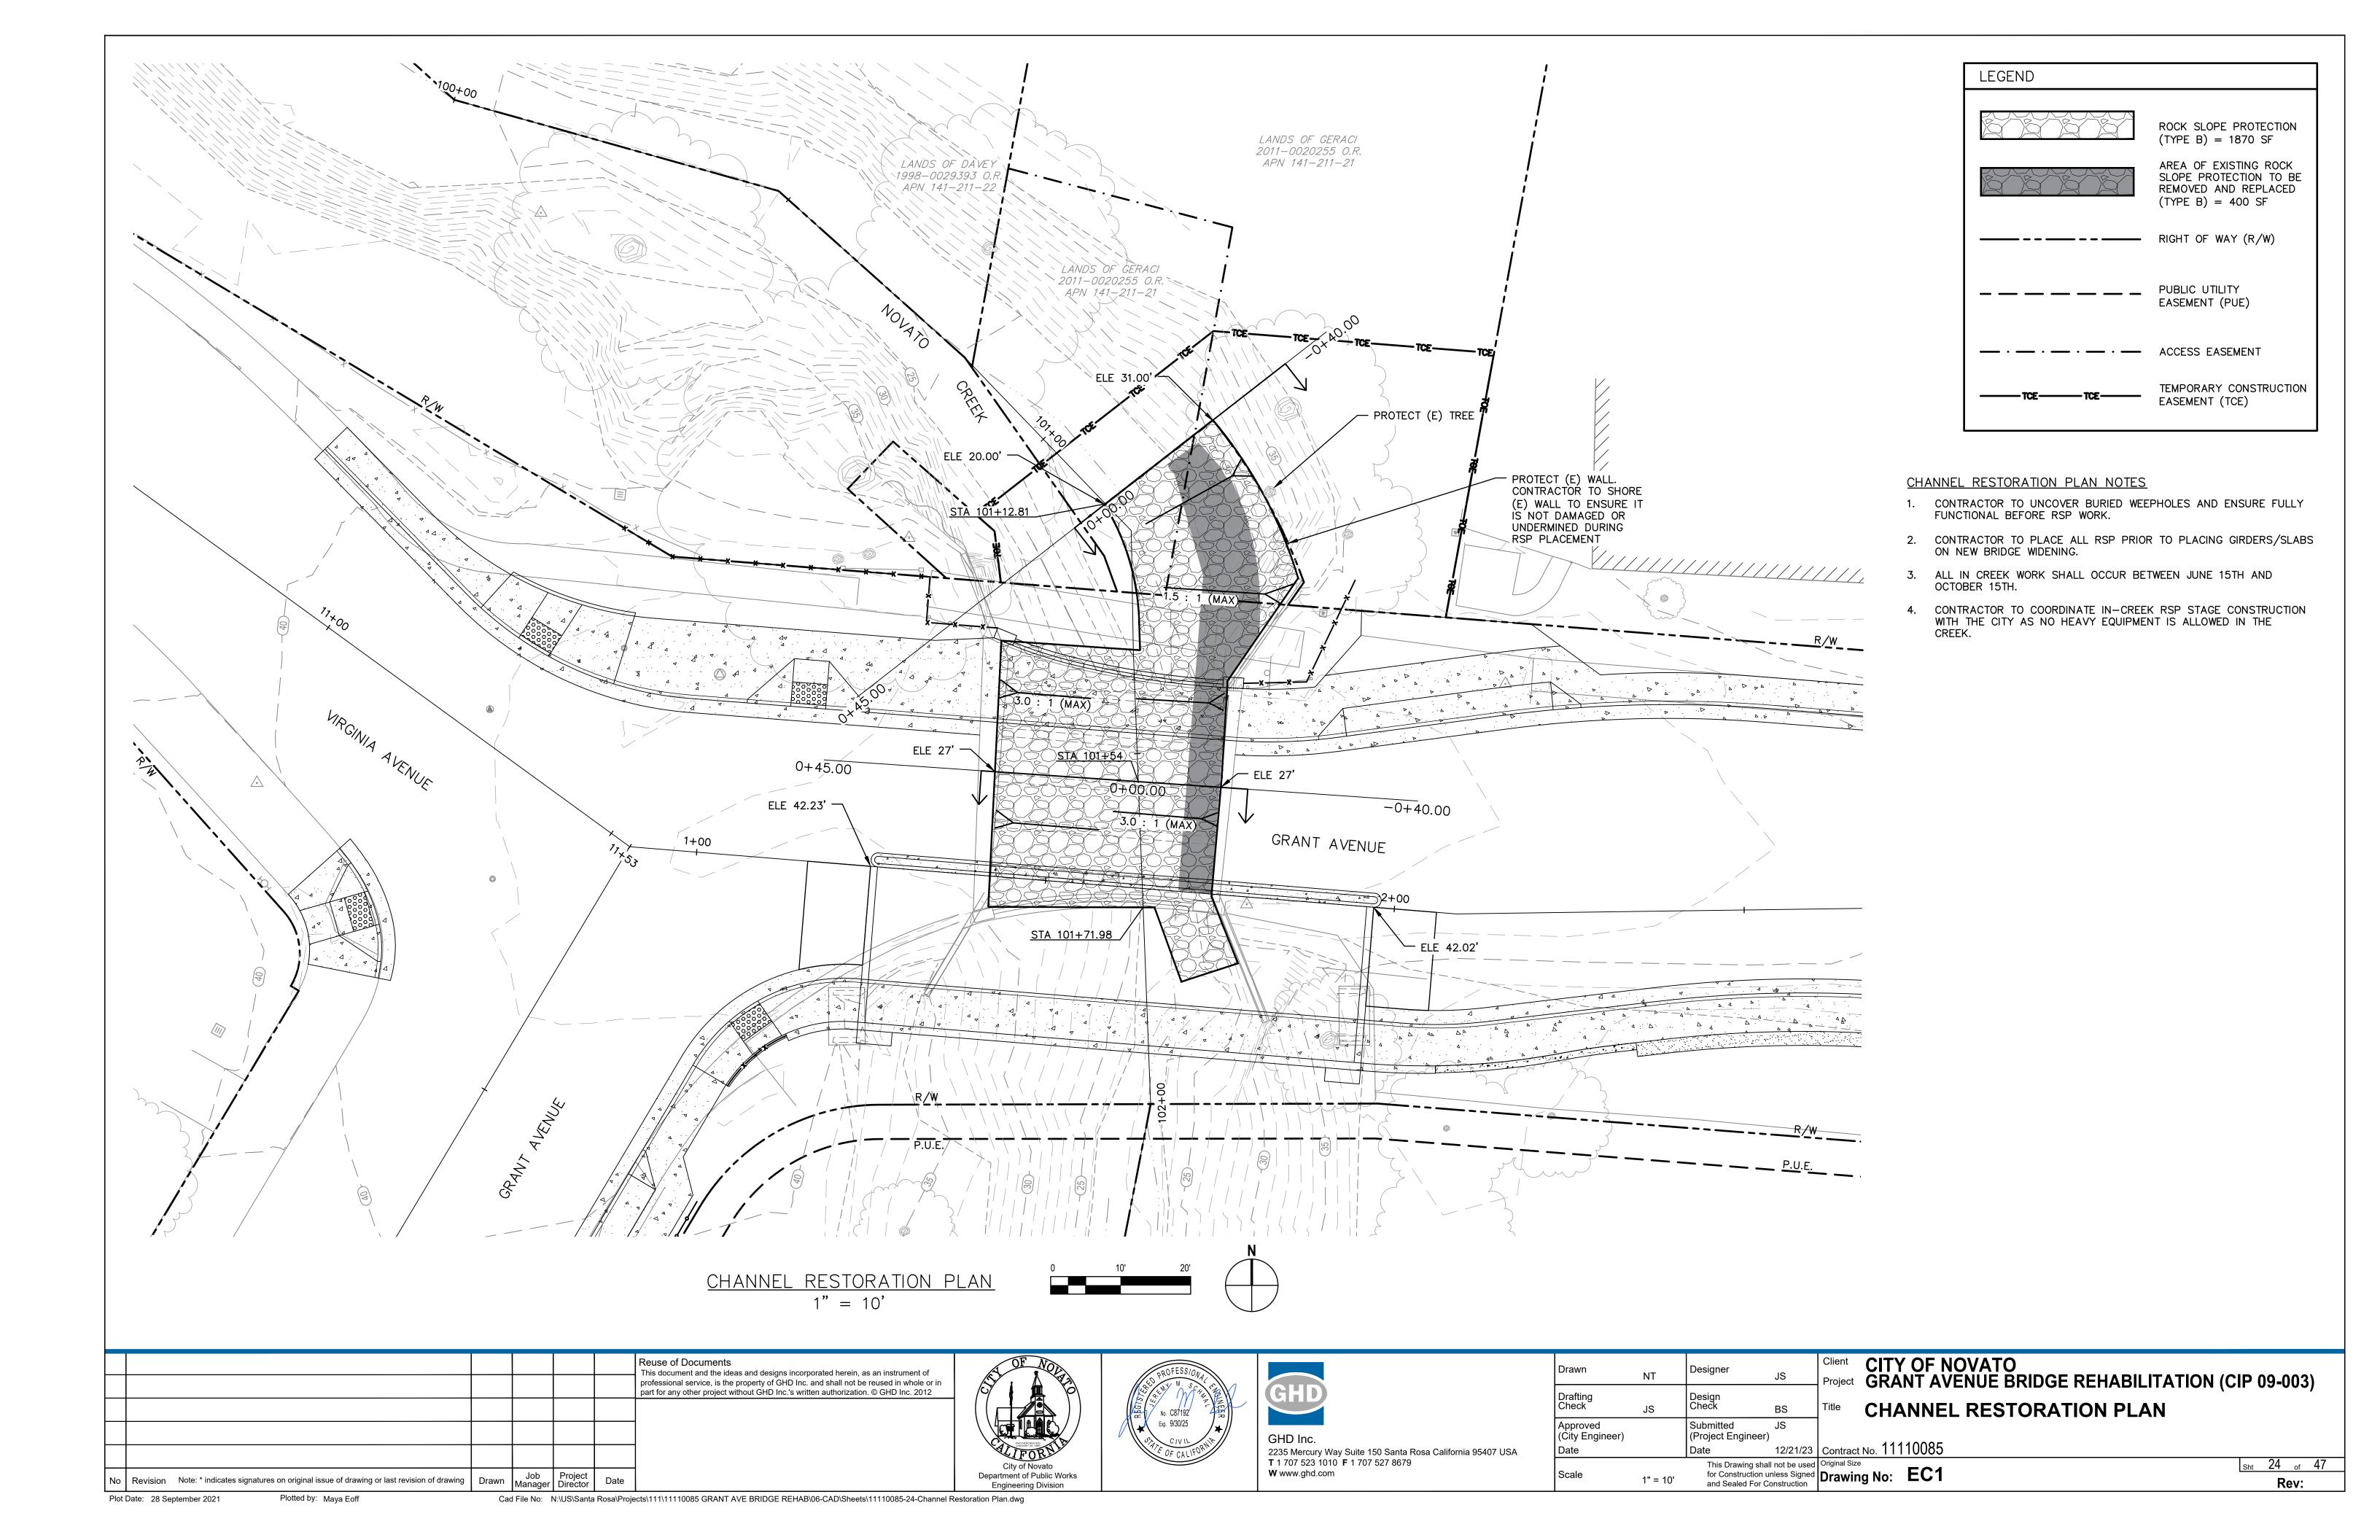
# CONSTRUCTION SPECIFICATIONS

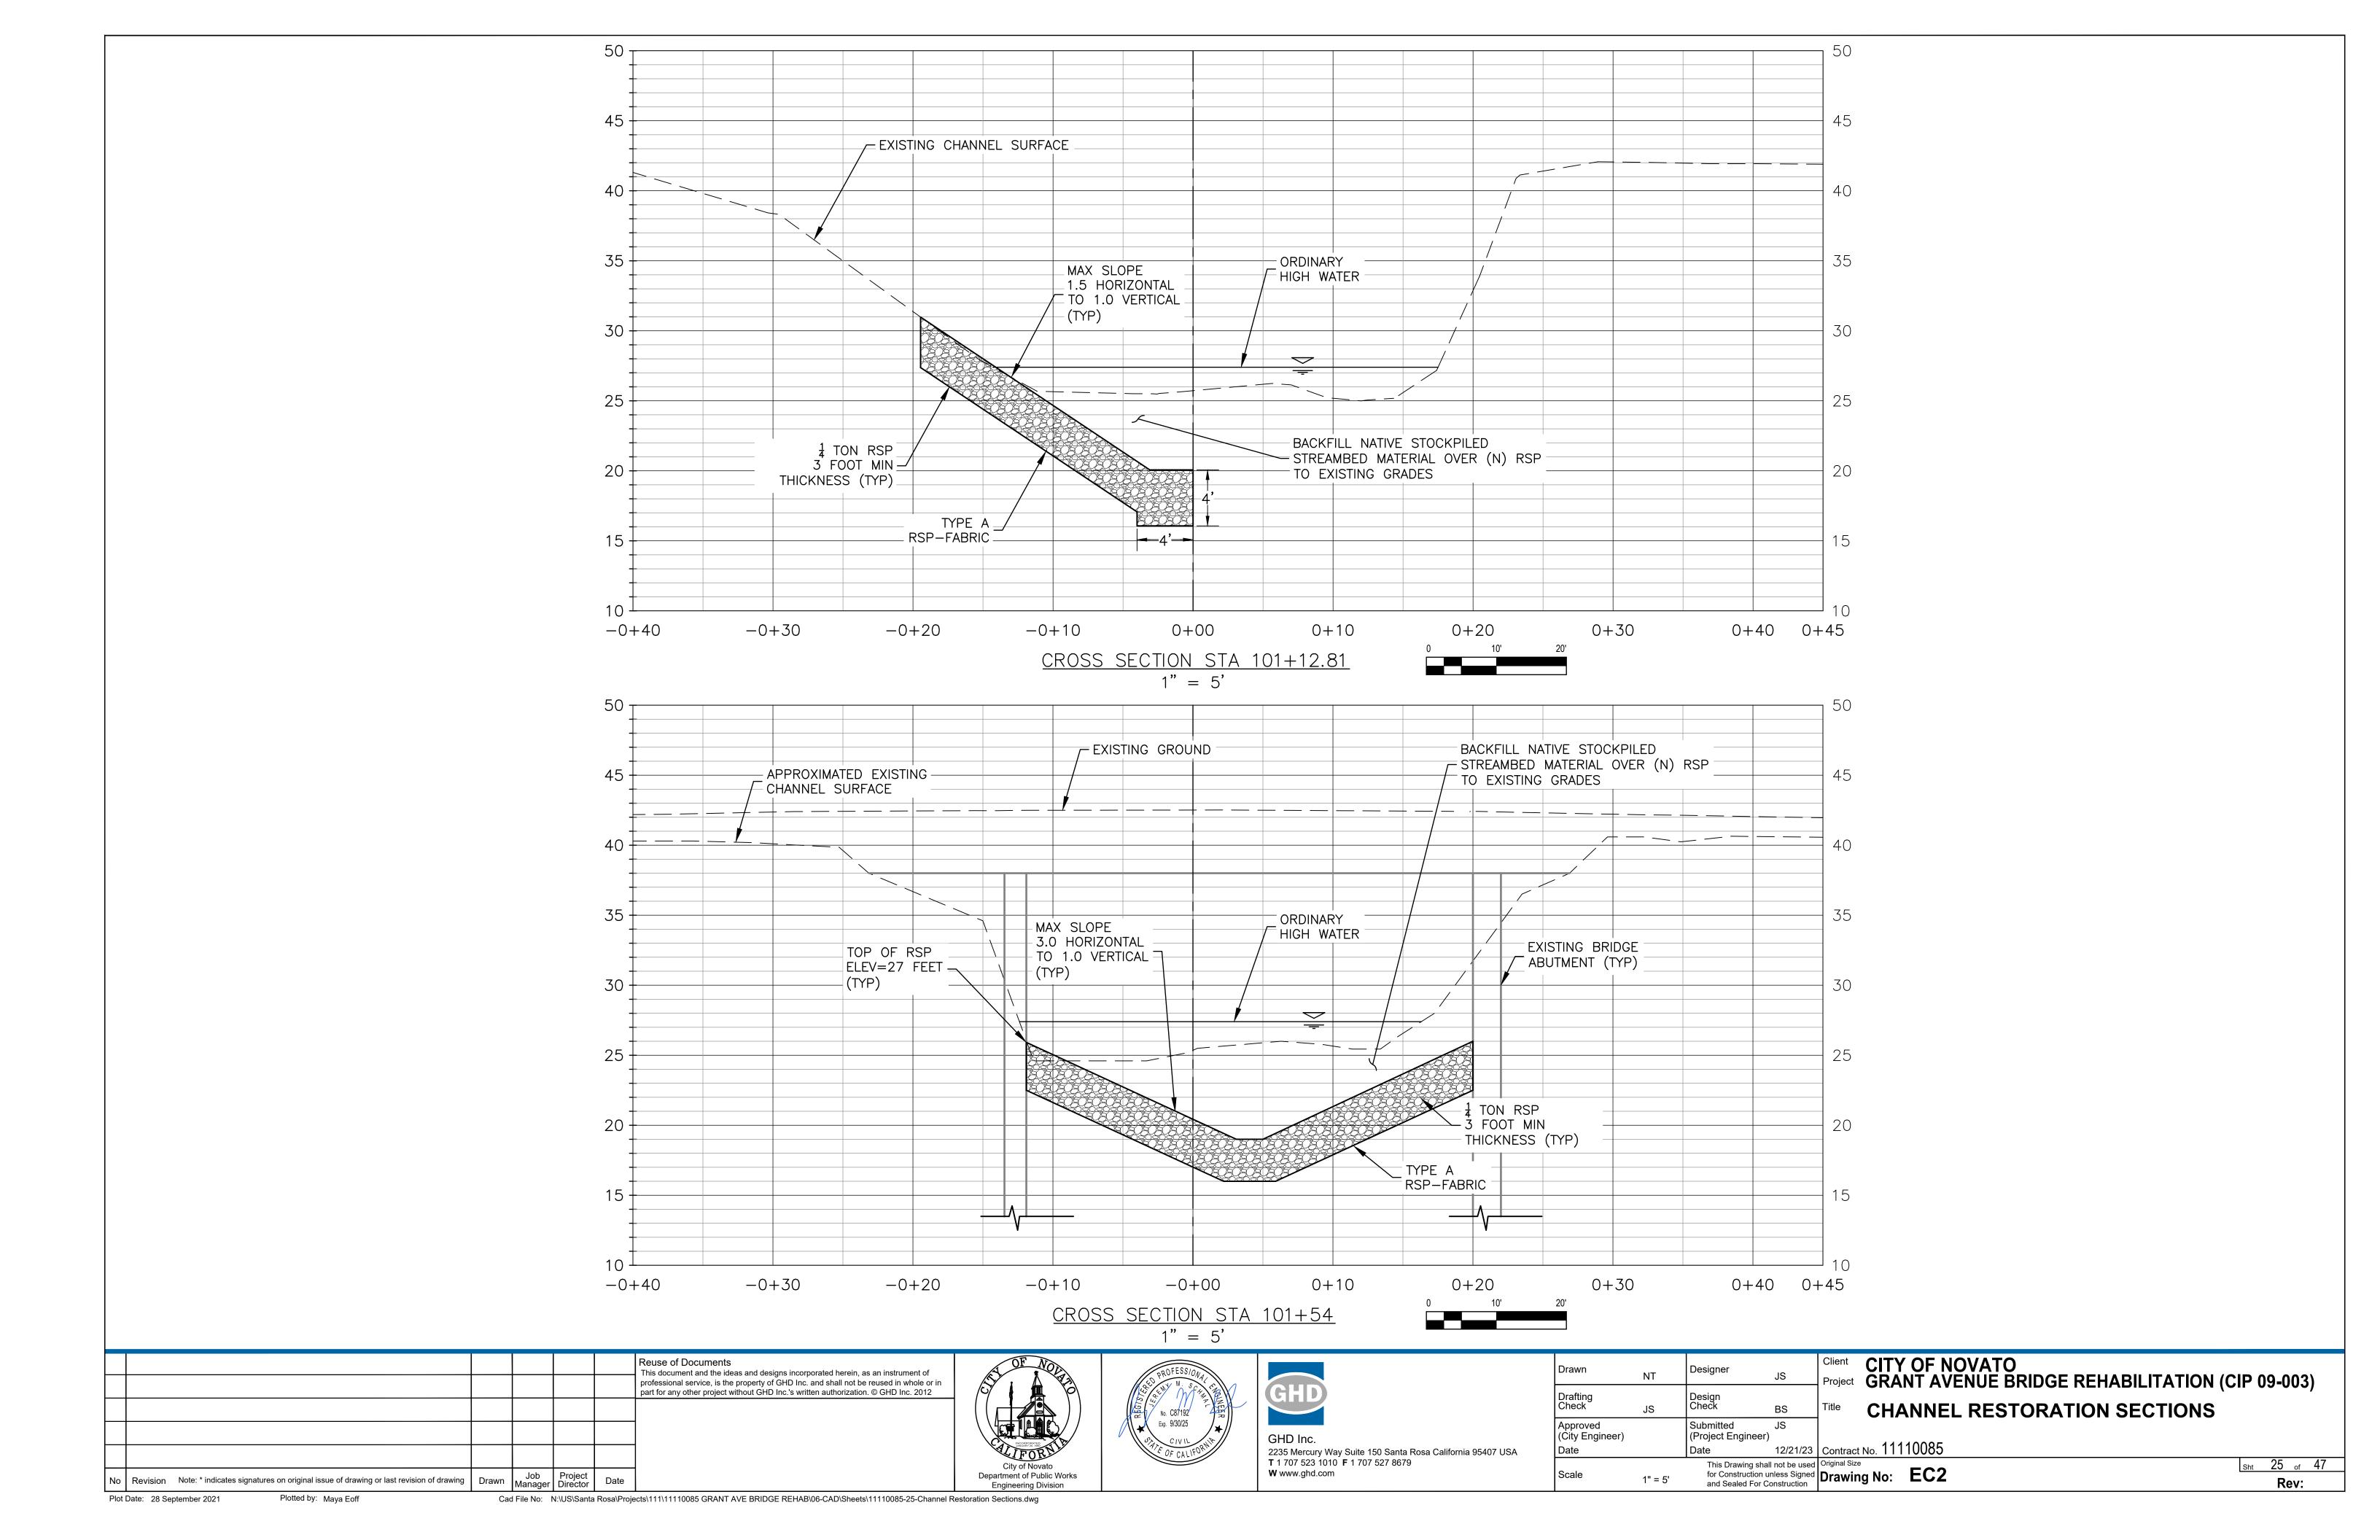- 1. THE HEIGHT OF A SILT FENCE SHALL NOT EXCEED 36 INCHES. ON SLOPES, THE FENCE LINE SHALL FOLLOW THE CONTOUR AS CLOSELY AS POSSIBLE. IN SMALL SWALES, THE FENCE LINE SHALL BE CURVED UPSTREAM AT THE SIDES TO DIRECT THE FLOW TOWARD THE MIDDLE OF THE FENCE.
- 2. IF POSSIBLE, THE FILTER FABRIC SHALL BE CUT FROM A CONTINUOUS ROLL TO AVOID THE USE OF JOINTS. WHEN JOINTS ARE NECESSARY, FILTER CLOTH SHALL BE SPLICED ONLY AT A SUPPORT POST, WITH A MINIMUM 6-INCH OVERLAP AND BOTH ENDS SECURELY FASTENED TO THE POST.
- 3. STEEL POSTS SHALL BE SPACED A MAXIMUM OF 10 FEET APART AND DRIVEN SECURELY INTO THE GROUND (MINIMUM OF 12 INCHES). WHEN EXTRA-STRENGTH FABRIC IS USED WITHOUT THE WIRE SUPPORT FENCE, OR WOOD POSTS ARE UTILIZED, POST SPACING SHALL NOT EXCEED 6 FEET.
- 4. A TRENCH SHALL BE EXCAVATED APPROXIMATELY 4 INCHES WIDE AND 8 INCHES DEEP ALONG THE LINE OF POST AND UPSLOPE FROM THE BARRIER.
- 5. WHEN STANDARD-STRENGTH FILTER FABRIC IS USED, A WIRE MESH SUPPORT FENCE SHALL BE FASTENED SECURELY TO THE UPSLOPE SIDE OF THE POSTS USING HEAVY DUTY WIRE STAPLES AT LEAST 1 INCH LONG, TIE WIRES OR HOG RINGS. THE WIRE SHALL EXTEND INTO THE TRENCH A MINIMUM OF 2 INCHES AND SHALL NOT EXTEND MORE THAN 36 INCHES ABOVE THE ORIGINAL GROUND SURFACE.
- 6. THE STANDARD-STRENGTH FILTER FABRIC SHALL BE STAPLED OR WIRED TO THE FENCE, AND 8 INCHES OF THE FABRIC SHALL EXTEND INTO THE TRENCH. THE FABRIC SHALL NOT EXTEND MORE THAN 36 INCHES ABOVE THE ORIGINAL GROUND SURFACE. FILTER FABRIC SHALL NOT BE STAPLED TO EXISTING TREES.
- 7. WHEN EXTRA-STRENGTH FILTER FABRIC AND CLOSER POST SPACING ARE USED, THE WIRE MESH SUPPORT FENCE MAY BE ELIMINATED. IN SUCH A CASE, THE FILTER FABRIC IS STAPLED OR WIRED DIRECTLY TO THE POSTS WITH ALL OTHER PROVISIONS OF NO. 6 ABOVE APPLYING.
- 8. THE TRENCH SHALL BE BACK FILLED AND THE SOIL COMPACTED OVER THE TOE OF THE FILTER FABRIC.
- 9. SILT FENCES SHALL BE REMOVED WHEN THEY HAVE SERVED THEIR USEFUL PURPOSE, BUT NOT BEFORE THE UPSLOPE AREA HAS BEEN PERMANENTLY STABILIZED.

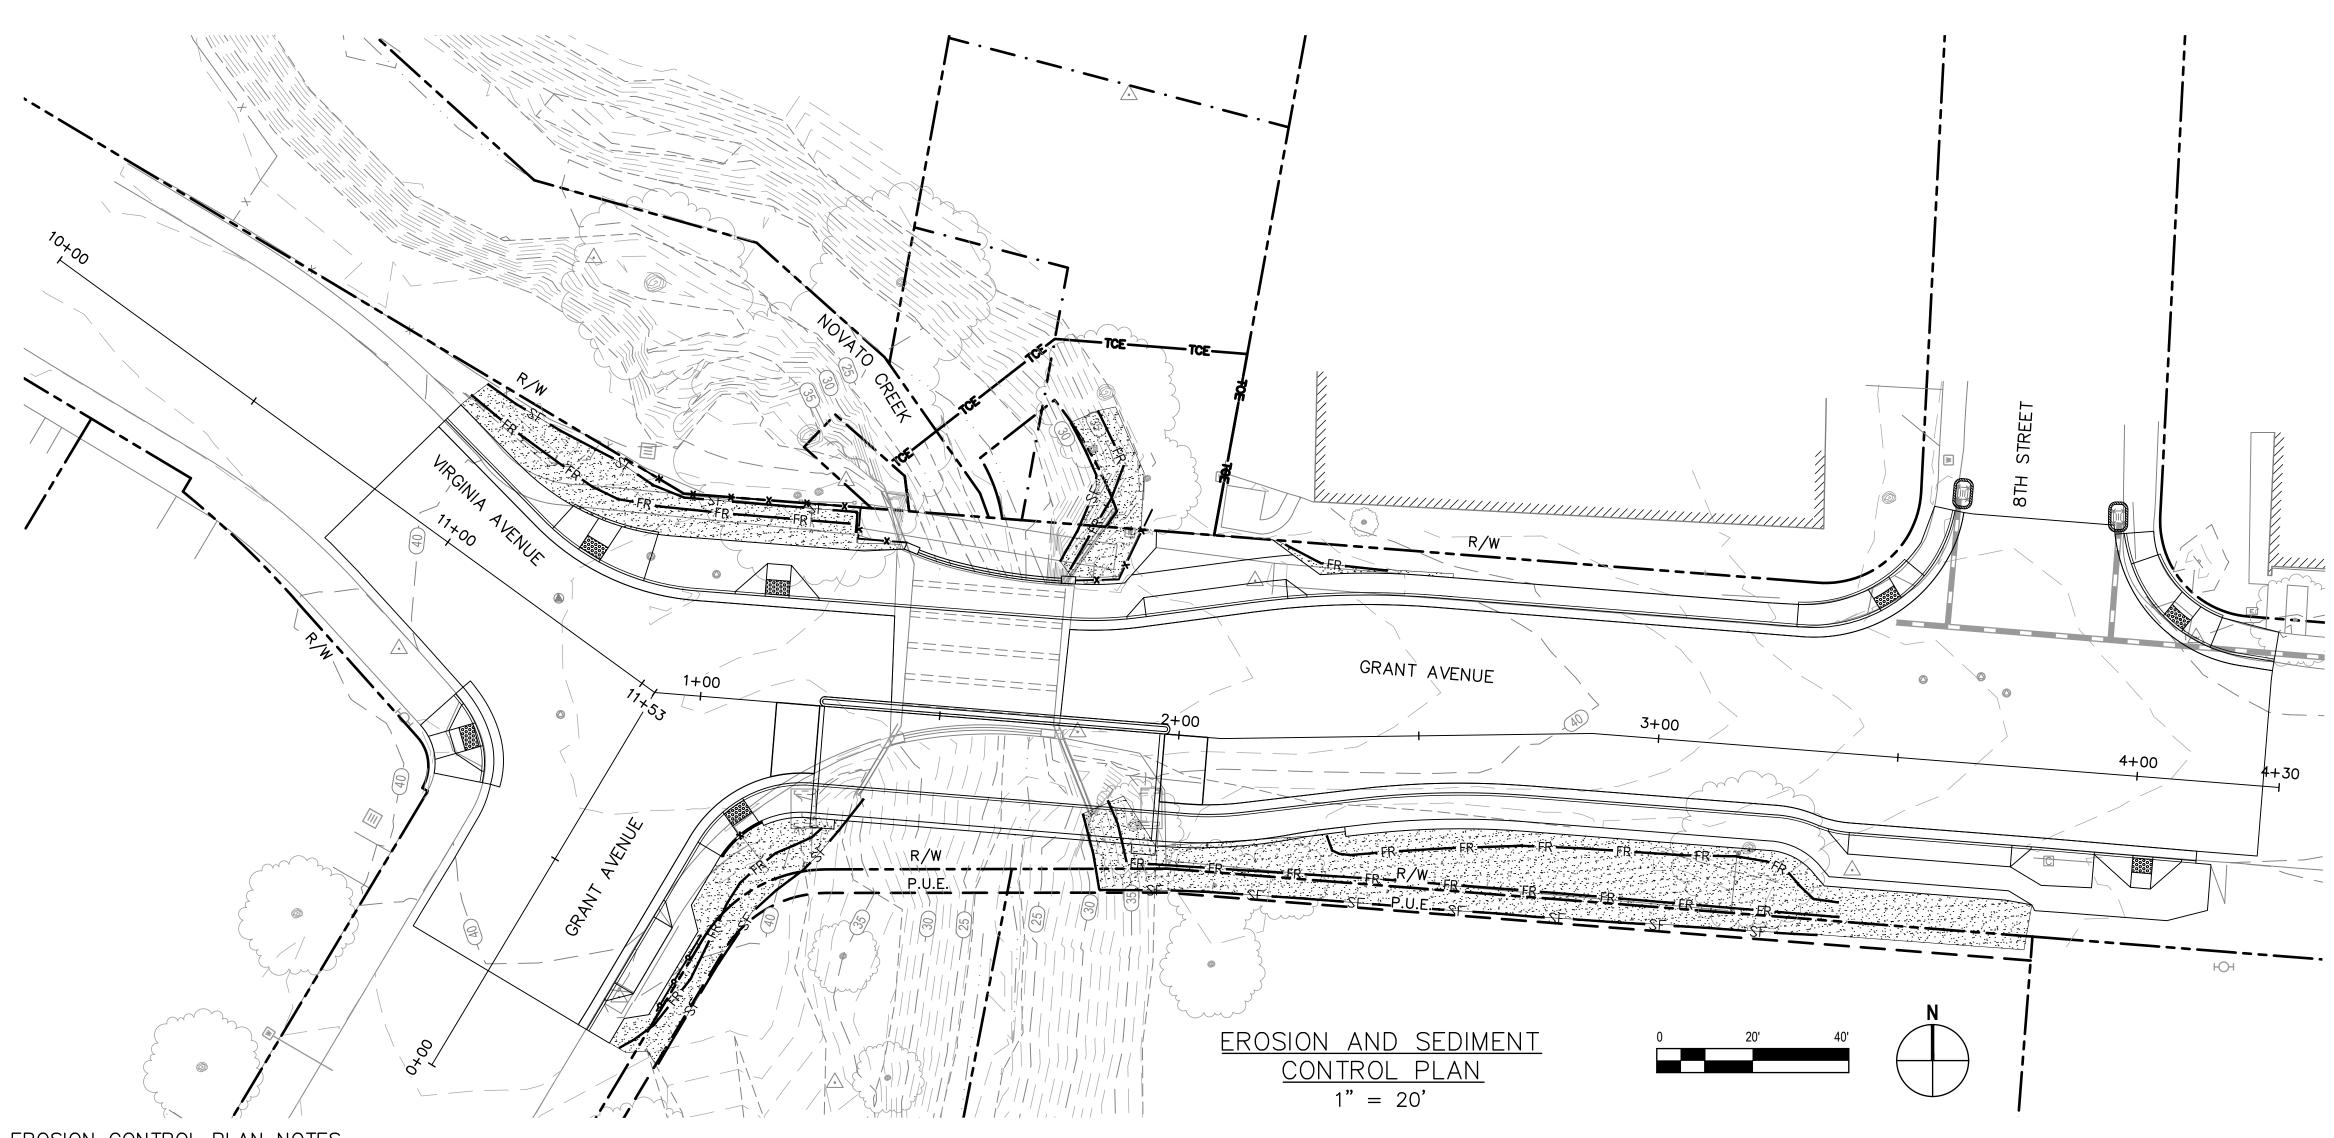1. FILTER FABRIC SHALL BE A PERVIOUS SHEET OF SYNTHETIC POLYMER COMPOSED OF AT LEAST 85% BY WEIGHT ETHYLENE, PROPYLENE, AMIDE, ESTER OF VINYLIDENE YARN, WOVEN OR NON WOVEN, AND SHALL CONTAIN STABILIZERS AND/OR INHIBITORS TO RESIST DETERIORATION BY HEAT, WATER AND ULTRAVIOLET LIGHT. THE FABRIC SHALL CONFORM TO THE FOLLOWING CRITERIA:

LEGEND

HYDROSEED

STD PLAN T51

STD PLAN T62

PUBLIC UTILITY EASEMENT (PUE)

ACCESS EASEMENT

EASEMENT (TCE)

STORM DRAIN INLET

RIGHT OF WAY (R/W)

FIBER ROLL (TYPE 1) PER CALTRANS STD PLAN T56

SILT FENCE PER CALTRANS


PROTECTION PER CALTRANS


TEMPORARY CONSTRUCTION

- A. THE EQUIVALENT OPENING SIZE (U.S. STANDARD SIEVE) SHALL BE WITHIN THE RANGE 70-100.
- B. THE TENSILE STRENGTH (ASTM D1682G) SHALL BE AT LEAST 120 POUNDS. THE STRENGTH OF FABRIC REQUIRED DEPENDS ON THE WIRE SUPPORT FENCE. THE STRENGTH GIVEN IS THE MINIMUM FOR A 6-INCH SQUARE MESH WIRE SUPPORT FENCE. IF EXTRA-STRENGTH FABRIC IS USED WITHOUT A SUPPORT FENCE. THE STRENGTH REQUIRED SHALL BE 200 POUNDS MINIMUM WITH POSTS SPACED ON 6 FOOT CENTERS.
- 2. POSTS FOR SILT FENCES SHALL BE EITHER 4-INCH-DIAMETER WOOD OR 1.33-POUNDS-PER LINEAR FOOT STEEL WITH A MINIMUM LENGTH OF 5 FEET. STEEL POSTS SHALL HAVE PROJECTIONS FOR FASTENING WIRE TO THEM.
- 3. WIRE FENCE REINFORCEMENT FOR SILT FENCES SHALL BE A MINIMUM OF 42 INCHES IN HEIGHT, SHALL BE A MINIMUM OF 14-GAUGE, AND SHALL HAVE A MAXIMUM MESH SPACING OF 6 INCHES.

# <u>MAINTENANCE</u>

- 1. SILT FENCES AND FILTER BARRIERS SHALL BE INSPECTED IMMEDIATELY AFTER EACH RAINFALL AND AT LEAST DAILY DURING PROLONGED RAINFALL AND REQUIRED REPAIRS SHALL BE MADE IMMEDIATELY.
- 2. SHOULD THE FABRIC ON A SILT FENCE OR FILTER BARRIER DECOMPOSE OR BECOME INEFFECTIVE PRIOR TO THE END OF THE BARRIER'S EXPECTED USABLE LIFE AND THE BARRIER STILL BE NECESSARY, THE FABRIC SHALL BE REPLACED PROMPTLY.
- 3. SEDIMENT DEPOSITS SHOULD BE REMOVED WHEN DEPOSITS REACH APPROXIMATELY ONE HALF THE HEIGHT OF THE BARRIER.
- 4. ANY SEDIMENT DEPOSITS REMAINING IN PLACE AFTER THE SILT FENCE OR FILTER BARRIER IS NO LONGER REQUIRED SHALL BE SPREAD TO CONFORM WITH THE EXISTING GRADE, PREPARED AND SEEDED.

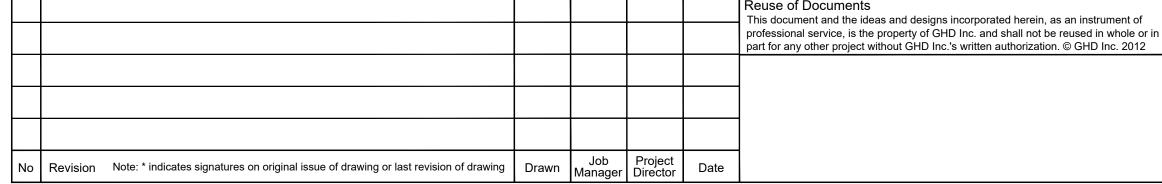

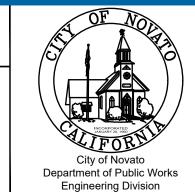





2235 Mercury Way Suite 150 Santa Rosa California 95407 USA **T** 1 707 523 1010 **F** 1 707 527 8679 W www.ghd.com

Drawn	NT	Designer	JS
Drafting Check	JS	Design Check	BS
Approved (City Engineer)		Submitted (Project Engineer)	JS
Date		Date	12/21/23
		This Drawing shall	not be used


and Sealed For Construction


CITY OF NOVATO Project GRANT AVENUE BRIDGE REHABILITATION (CIP 09-003)


**EROSION AND SEDIMENT CONTROL PLAN** 


Contract No. 11110085


Sht 26 of 47 for Construction unless Signed and Sealed For Construction Drawing No: EC3 Rev:

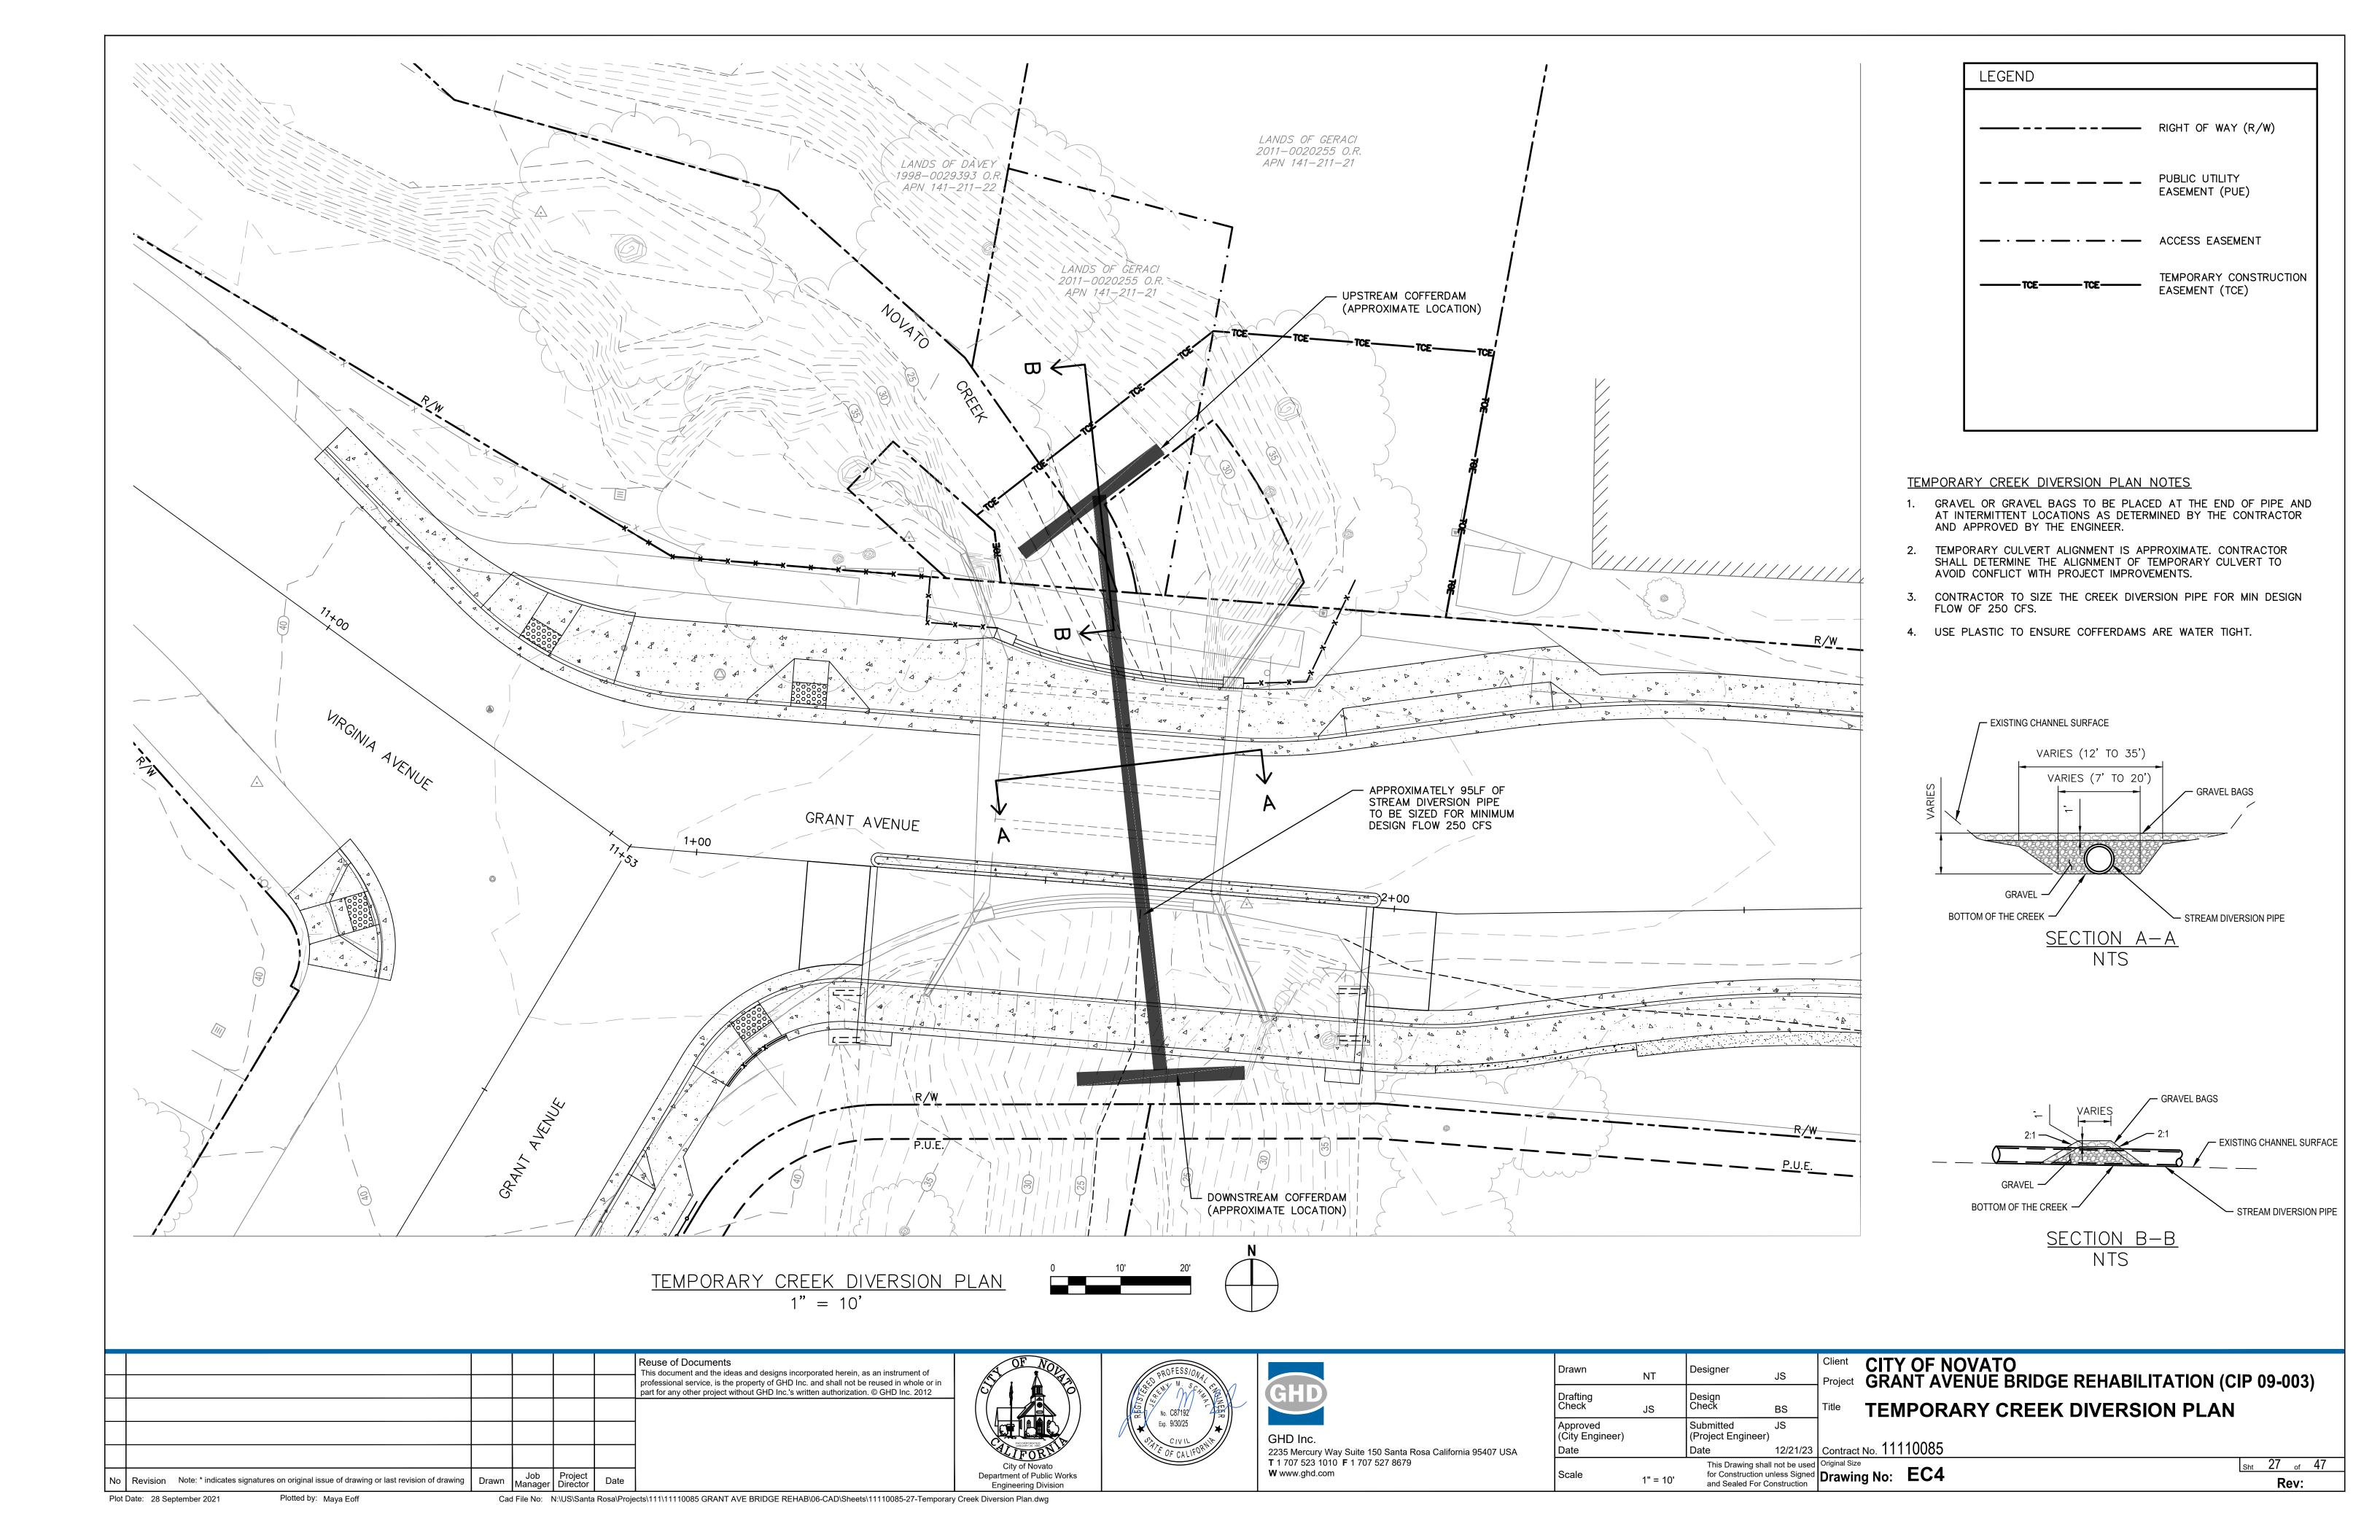

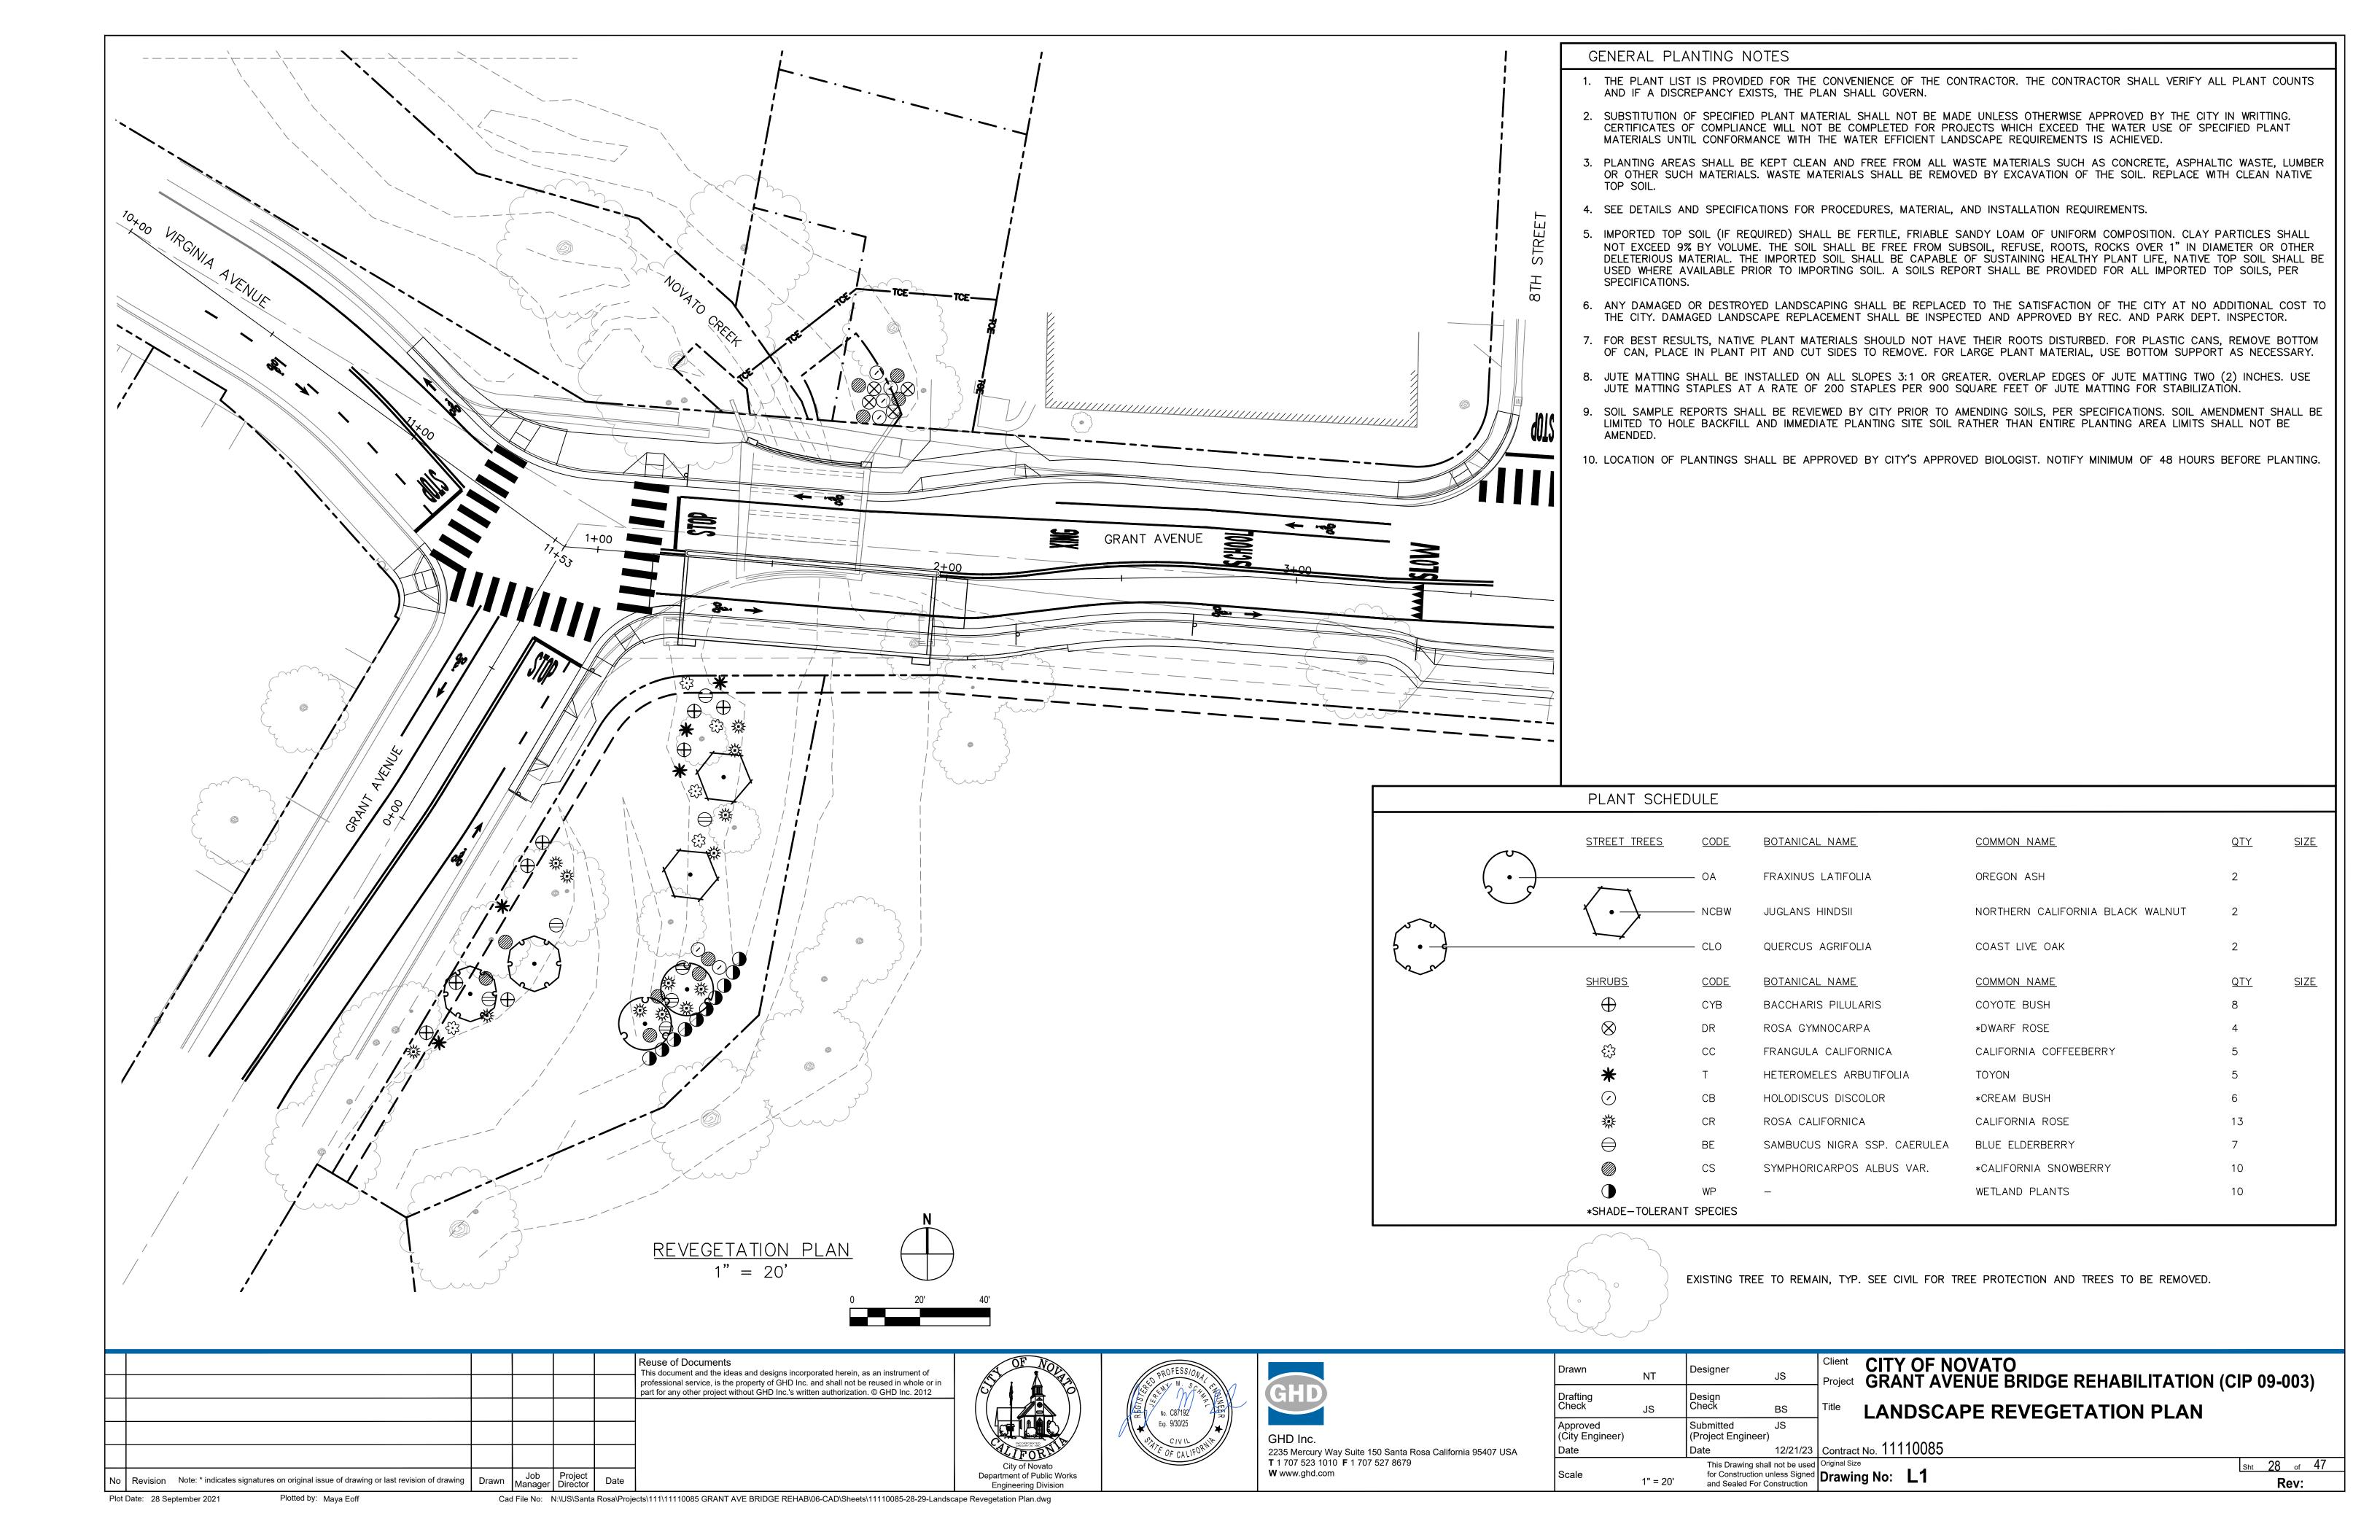

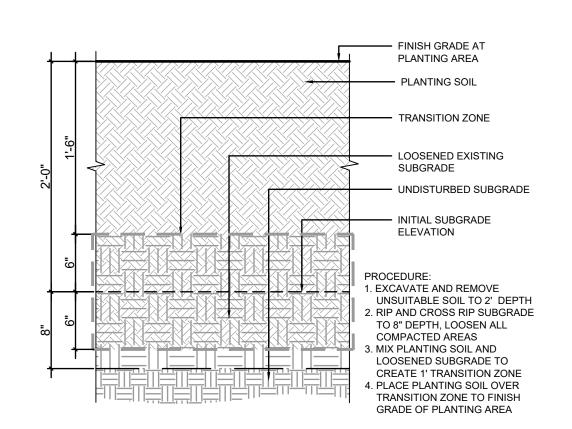

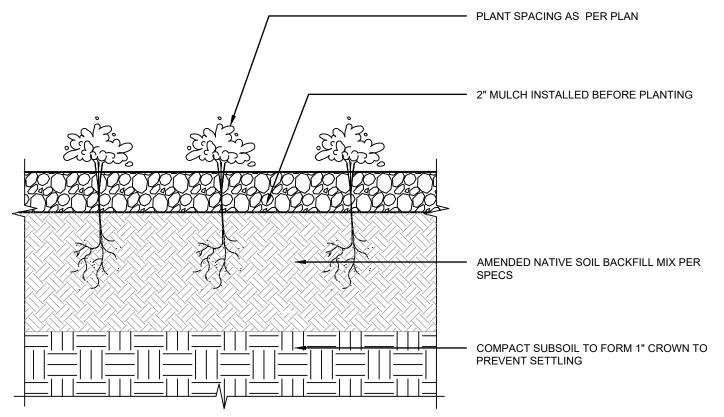


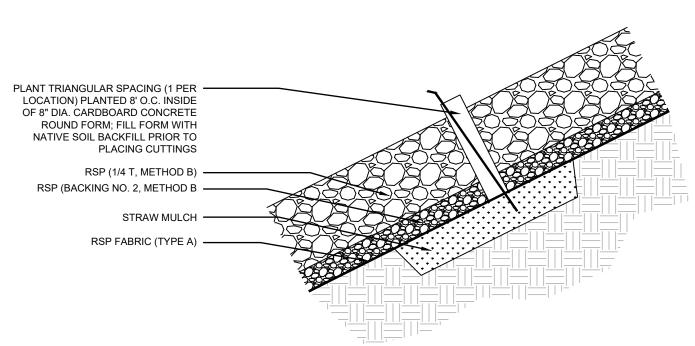








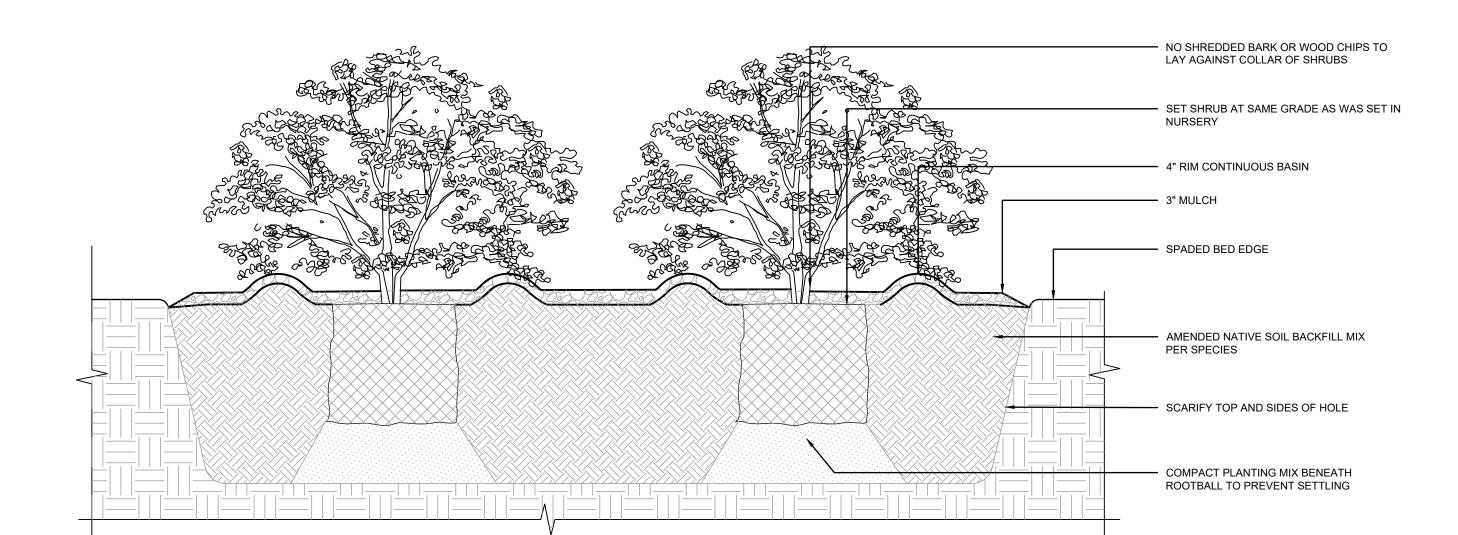




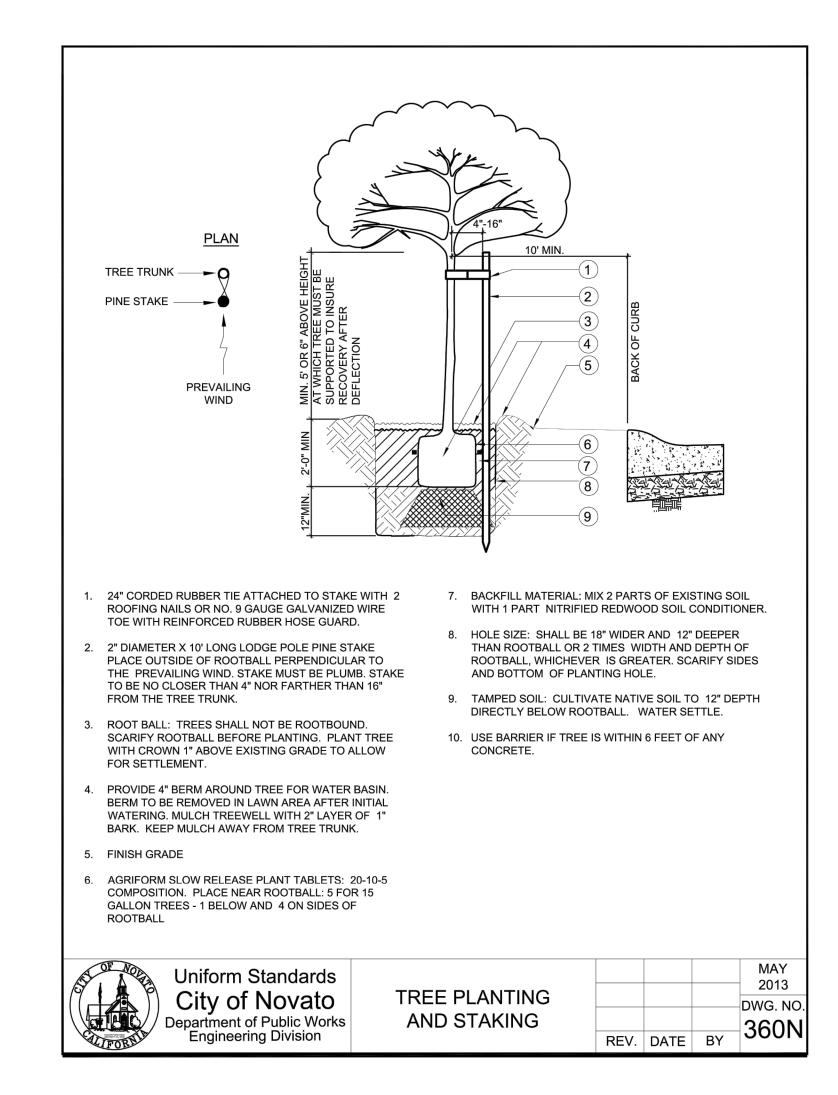



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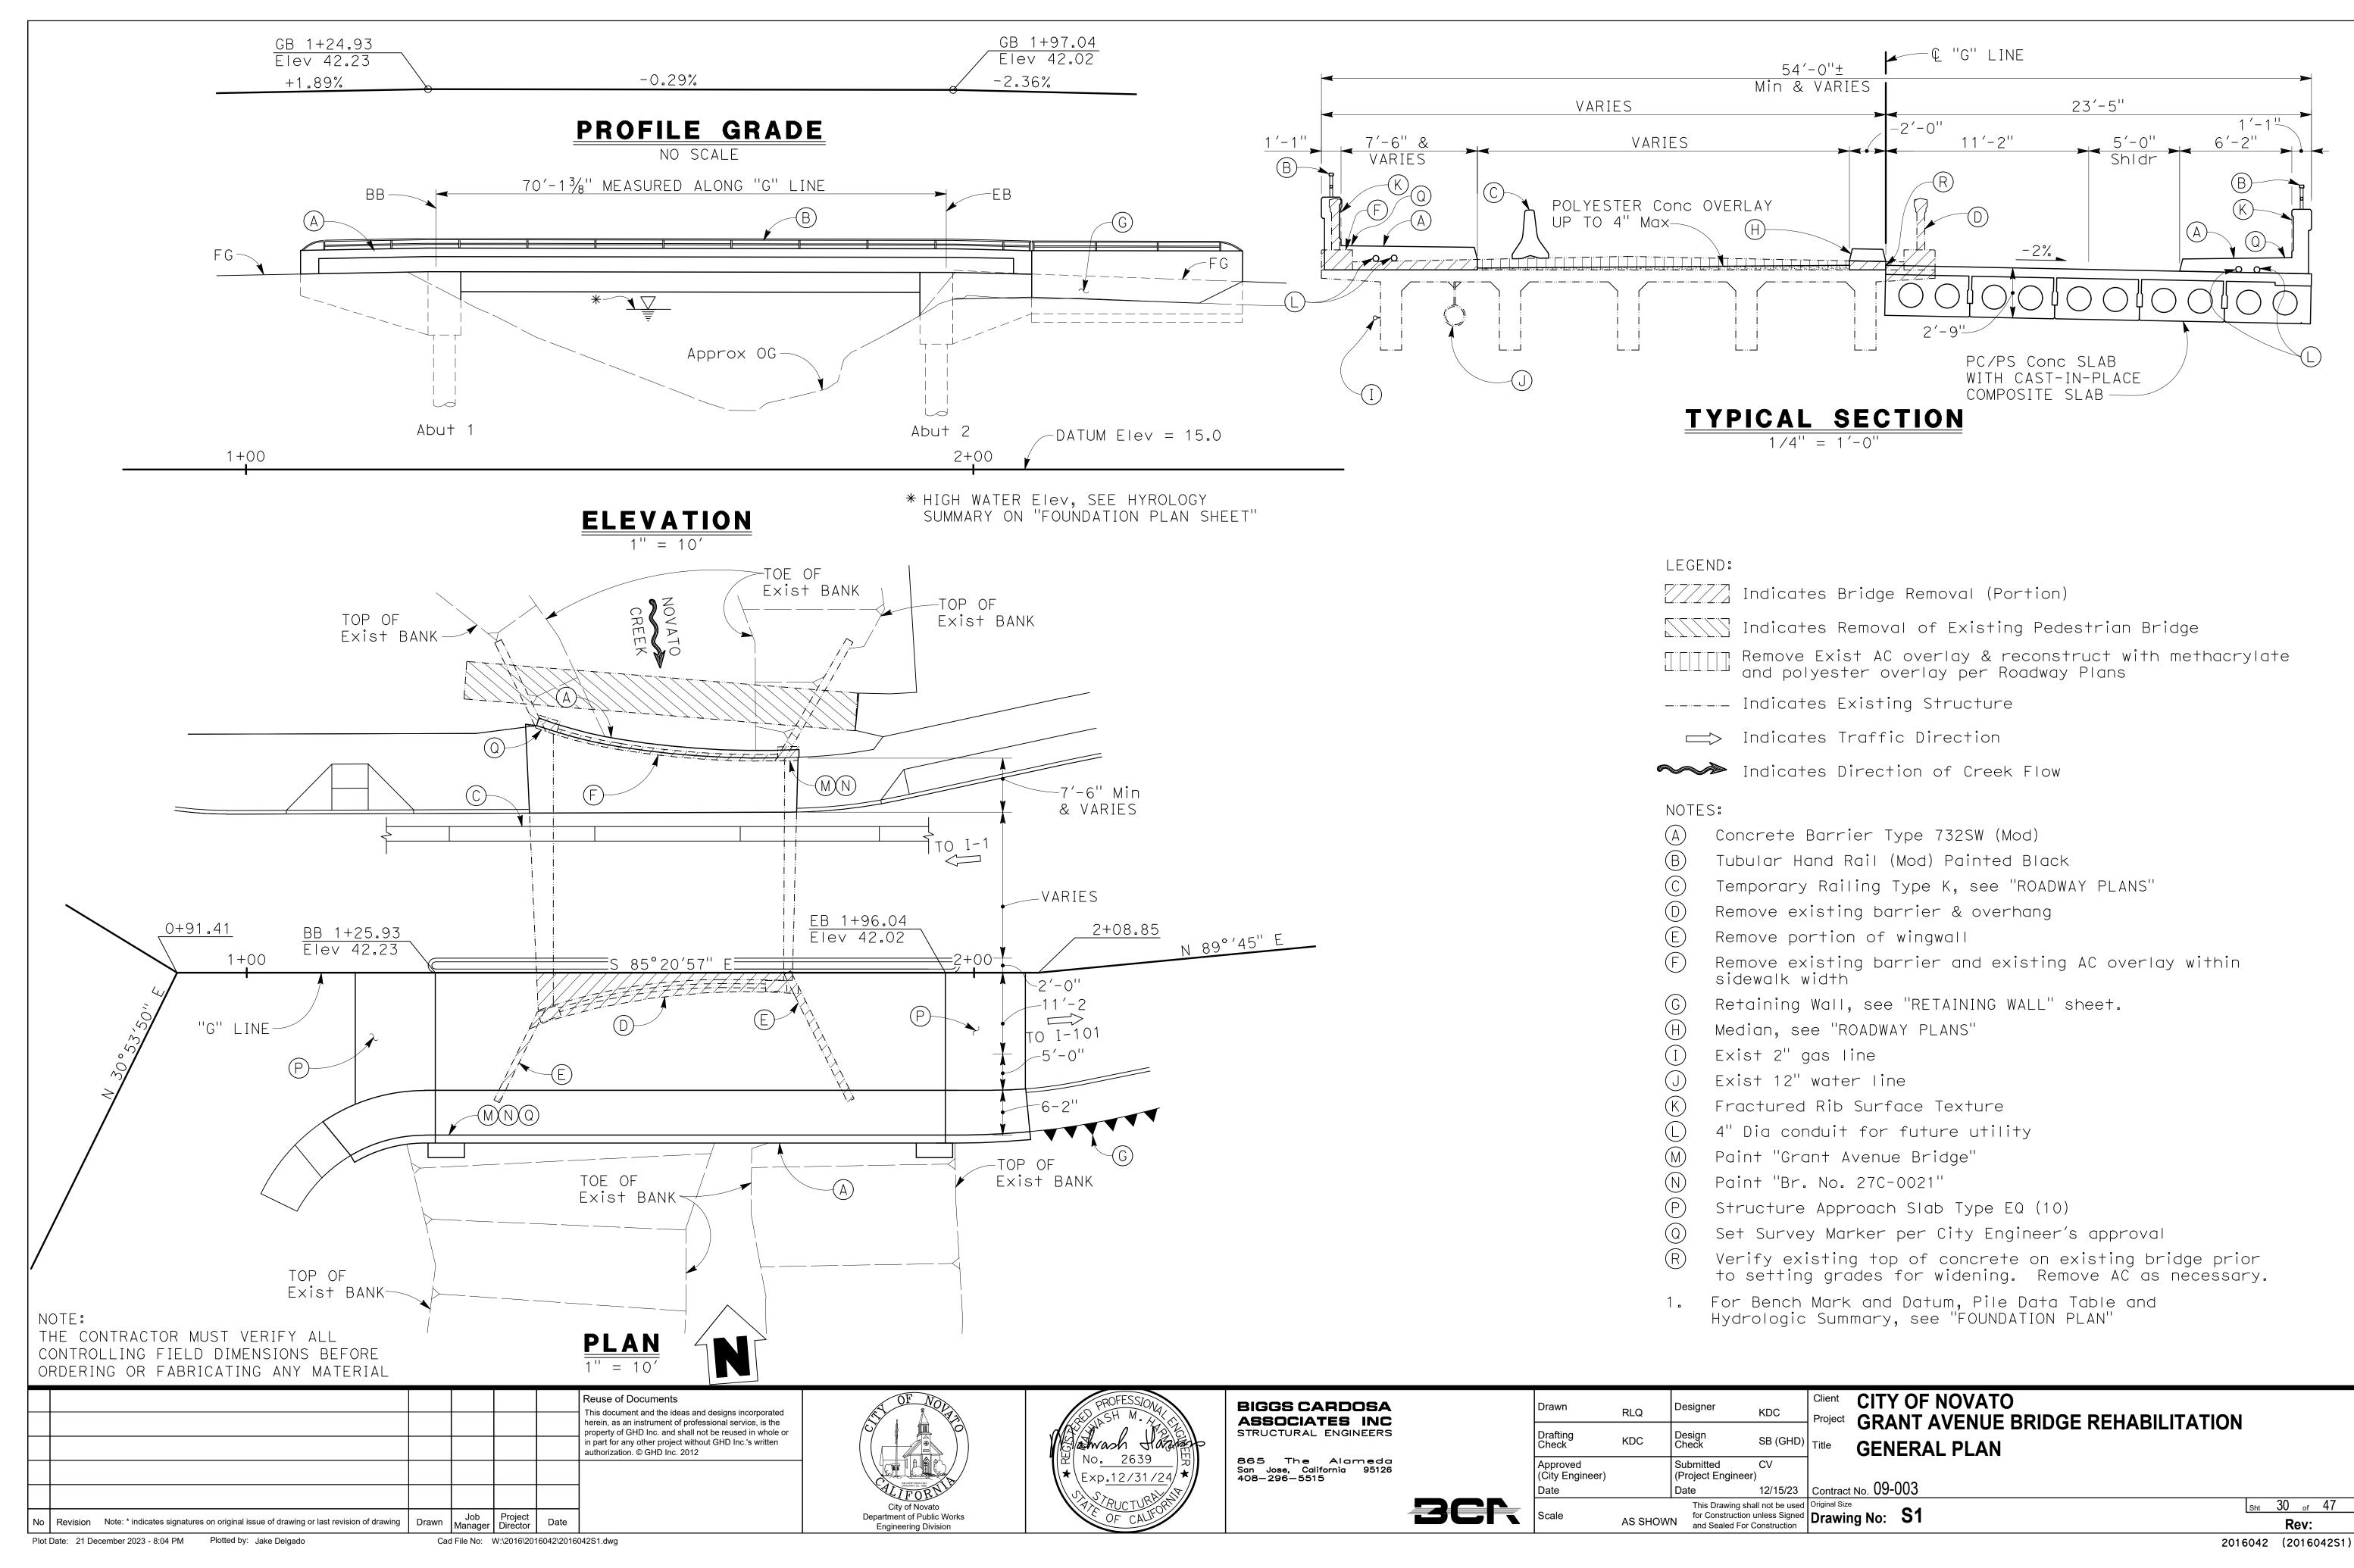
GHD Inc.
2235 Mercury Way Suite 150 Santa Rosa California 95407 USA
<b>T</b> 1 707 523 1010 <b>F</b> 1 707 527 8679
<b>W</b> www.ghd.com

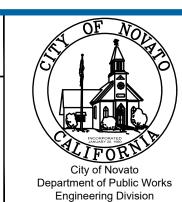Drawn	NT	Designer	JS	Client Project	CITY OF GRANT A
Drafting Check	JS	Design Check	BS	Title	LANDSO
Approved (City Engineer)		Submitted (Project Engineer)	JS		
Date		Date	12/21/23	Contract	No. 11110085
Scale	1" = 20'	This Drawing shall for Construction ur and Sealed For Co	nless Signed	Original Size  Drawin	

Client Project	CITY OF NOVATO GRANT AVENUE BRIDGE REHABILITATION (CIP 09-00
Title	LANDSCAPE PLANTING DETAILS

21/23 Contract No. 11110085

L2 Sht 29 of 47 Rev:




# INDEX TO BRIDGE PLANS

SHEET	TITLE
S1	GENERAL PLAN
S2	INDEX TO PLANS
S3	FOUNDATION PLAN
S4	ABUTMENT LAYOUT
S5	ABUTMENT DETAILS No. 1
S6	ABUTMENT DETAILS No. 2
S7	ABUTMENT DETAILS No. 3
S8	ABUTMENT DETAILS No. 4
S9	TYPICAL SECTION No. 1
S10	TYPICAL SECTION No. 2
S11	PRECAST PRESTRESSED CONCRETE SLAB DETAILS No. 1
S12	PRECAST PRESTRESSED CONCRETE SLAB DETAILS No. 2
S13	PARTIAL REMOVAL PLAN
S14	JOINT ARMOR FOR PEDESTRIAN WALKWAYS
S15	MISCELLANEOUS BARRIER DETAILS
S16	STRUCTURE APPROACH SLAB TYPE EQ (10)
S17	RETAINING WALL LAYOUT & DETAILS
S18	LOG OF TEST BORINGS


# 2023 CALTRANS STANDARD PLANS

A3A A3B A3C A1OA A1OB A1OC A1OD A1OE A1OF	ABBREVIATIONS (SHEET 1 OF 3) ABBREVIATIONS (SHEET 2 OF 3) ABBREVIATIONS (SHEET 3 OF 3) LEGEND - LINES AND SYMBOLS (SHEET 1 OF 5) LEGEND - LINES AND SYMBOLS (SHEET 2 OF 5) LEGEND - LINES AND SYMBOLS (SHEET 3 OF 5) LEGEND - LINES AND SYMBOLS (SHEET 4 OF 5) LEGEND - LINES AND SYMBOLS (SHEET 5 OF 5) LEGEND - SOIL (SHEET 1 OF 2) LEGEND - SOIL (SHEET 2 OF 2) LEGEND - ROCK
A10H	
A62B A62C	LIMITS OF PAYMENT FOR EXCAVATION AND BACKFILL - BRIDGE SURCHARGE AND WALL LIMITS OF PAYMENT FOR EXCAVATION AND BACKFILL - BRIDGE
T3A B0-1 B0-3 B0-13 B6-21 B11-51 B11-58 B11-59	TEMPORARY RAILING TYPE K BRIDGE DETAILS BRIDGE DETAILS BRIDGE DETAILS JOINT SEALS (MAXIMUM MOVEMENT RATING = 2") TUBULAR HAND RAILING CONCRETE BARRIER TYPE 732SW (SHEET 1 OF 2) CONCRETE BARRIER TYPE 732SW (SHEET 2 OF 2)
	CONTRACT DANNIER THE 1929W (SHEET 2 OF 2)

# LEGEND

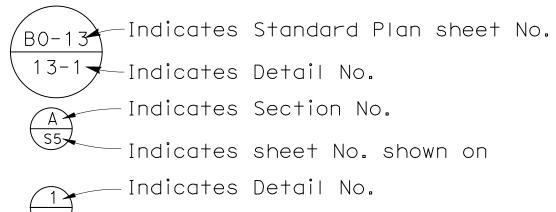

-Indicates sheet No. shown on

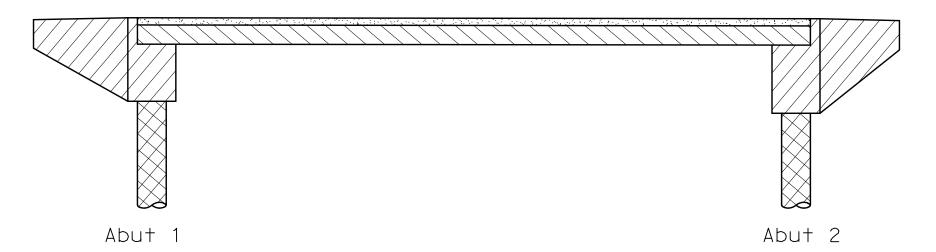

# LEGEND:

STRUCTURAL CONCRETE, BRIDGE (POLYMER FIBER) (f'c = 4.0 ksi)

PRECAST PRESTRESSED CONCRETE SLAB, SEE PRESTRESSING NOTES ON "PRECAST PRESTRESSED CONCRETE SLAB DETAILS No. 1" SHEET FOR CONCRETE COMPRESSIVE STRENGTH

STRUCTURAL CONCRETE, BRIDGE (f'c = 4.0 ksi)

CIDH CONCRETE (f'c = 3.6 ksi)

# CONCRETE STRENGTH AND TYPE LIMITS

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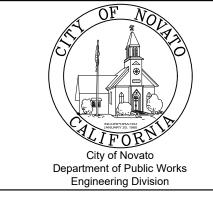
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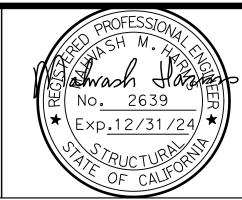
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Plot	Date: 21 December 2023 - 8:05 PM Plotted by: Jake Delgado	Cac	File No:	W:\2016\201	6042\20160





**BIGGS CARDOSA** ASSOCIATES INC STRUCTURAL ENGINEERS

865 The Alameda San Jose, California 95126 408–296–5515

# Scale Scale

#### **CITY OF NOVATO** RLQ **GRANT AVENUE BRIDGE REHABILITATION** Drafting Check SB (GHD) Title **INDEX TO PLANS** CV Approved Submitted

(City Engineer) (Project Engineer) 12/15/23 | Contract No. 09-003

This Drawing shall not be used for Construction unless Signed and Sealed For Construction

Original Size

Drawing No: \$2 Sht 31 of 47

Rev:

GENERAL NOTES LOAD & RESISTANCE FACTOR DESIGN

AASHTO LRFD Bridge Design Specifications, 6th Edition and DESIGN: California Amendments, preface dated January, 2014

Caltrans Seismic Design Criteria (SDC) Version 1.7 SEISMIC DESIGN: dated April 2013

Includes 35 psf for future wearing surface and DEAD LOAD:

100 plf for future utilities. HL93 and permit design load. LIVE LOAD:

fy = 60 ksiCONCRETE:

> f'c = 3.6 ksi (except as shown on "CONCRETE STRENGTH & TYPE LIMITS" diagram

n = 8


PRESTRESSED CONCRETE: See "PRESTRESSING NOTES" on "PRECAST PRESTRESSED CONCRETE SLAB DETAILS No. 1" sheet

ARS Curve by Caltrans Online SEISMIC LOAD:

Probabilistic for  $V_{s30} = 290 \text{ m/s} \& 230 \text{ m/s}$ Moment Magnitude = 7.3


Peak Ground Acceleration = 0.647g with the following modifications:

- 1. No change of Sa for structural periods < 0.5 seconds
- 2. 20% increase of Sa for structural periods  $\geq$  1 second
- 3. Linear interpolation of Sa for structural periods between 0.5 and 1 second.

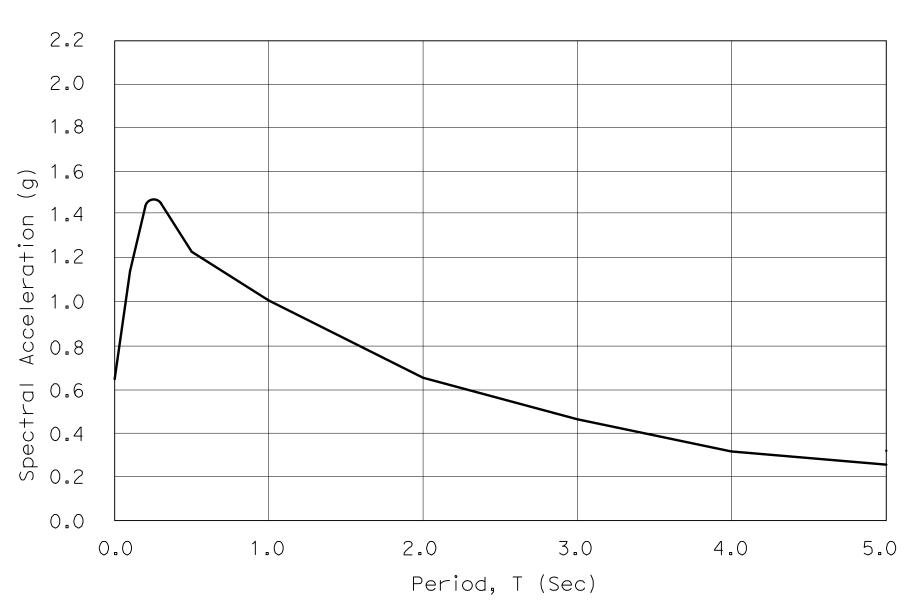

# ARS DESIGN CURVE

NO SCALE

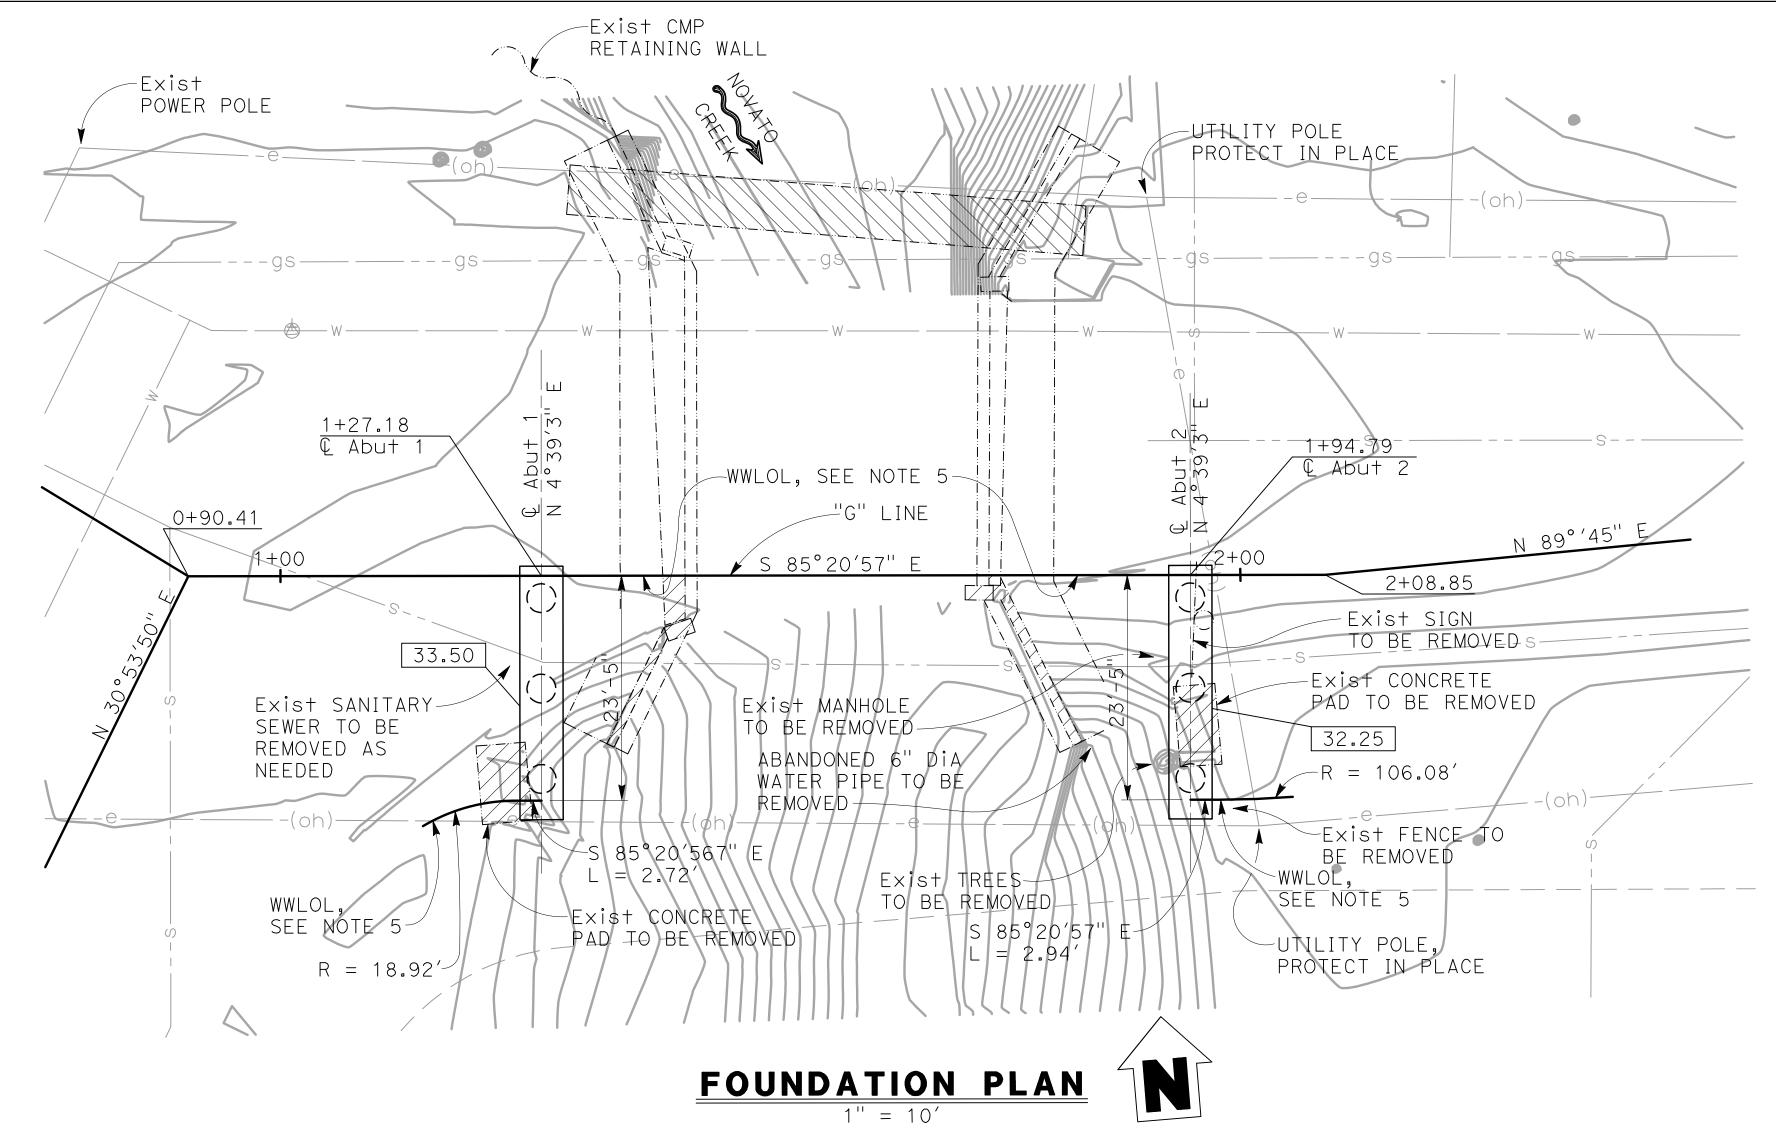

	BENCH MARK AND DATUM							
Monument	Coord Northing	inates Easting	Elev (NAVD 88)	Description/Location				
8	2233086.041	5962456.871	40.45	BEING A CUT "X" IN CONCRETE AT THE SOUTHWEST CORNER OF GRANT AND VIRGINIA AVENUES				


	PILE DATA TABLE									
LOCATION	CUT-OFF PILE TYPE Elev		NOMINAL RESISTANCE		DESIGN TIP Elev	SPECIFIED TIP Elev	ESTIMATED BEDROCK			
LOCATION	FILE HE	(f+)	COMPRESSION	TENSION	(f+)	(f+)	Elev (ft)			
Abut 1	36" Dia CIDH	33.75	480	N/A	-6 (a); 22 (b); -3.5 (c)	-6	0			
Abut 2	36" Dia CIDH	32.50	480	N/A	-9 (a); 21 (b); 3.0 (c)	-9	0			

# NOTES:

- 1. Design tip elevations for Abutments are controlled by: (a) Compression; (b) Settlement; (c) Lateral Load.
- 2. Specified Tip Elevation must not be raised above the Design Tip Elevation for lateral load, tension load, and tolerable settlement.

THE CONTRACTOR MUST VERIFY ALL CONTROLLING FIELD DIMENSIONS BEFORE ORDERING OR FABRICATING ANY MATERIAL

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Plot	Plot Date: 21 December 2023 - 8:06 PM						

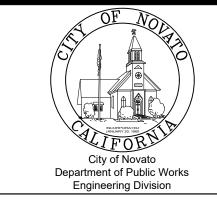



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# Scale Scale

#### **CITY OF NOVATO** RLQ **GRANT AVENUE BRIDGE REHABILITATION** SB (GHD) Title KDC **FOUNDATION PLAN** CV Submitted Approved (City Engineer) (Project Engineer)

12/15/23 | Contract No. 09-003 This Drawing shall not be used for Construction unless Signed and Sealed For Construction

Original Size

Drawing No: \$3

Sht 32 of 47

2016042 (2016042S3)

# HYDROLOGIC SUMMARY

(PROVIDED BY GHD 6/21/2016)

BASE FLOOD OVERTOPPING BASIN AREA: 18 square miles DESIGN FLOOD N/A FREQUENCY (YEARS) 700 3,300 N/A DISCHARGE (CFS) 31.04 N/A WATER SURFACE ELEVATION AT BRIDGE (FT)

FLOOD PLAIN DATA ARE BASED UPON INFORMATION AVAILABLE WHEN THE PLANS WERE PREPARED AND ARE SHOWN TO MEET FEDERAL REQUIREMENTS. THE ACCURACY OF SAID INFORMATION IS NOT WARRANTED BY THE CITY AND INTERESTED OR AFFECTED PARTIES SHOULD MAKE THEIR OWN INVESTIGATIONS.

# NOTES:

- 1. Utilities shown are for illustrative purposes only. Verify utility locations and whether they are to be relocated, abandoned, etc, with Roadway Plans.
- 2. For property delineations and descriptions, see Roadway Plans.
- 3. Topographic information: Cinquini & Passarino, Inc., Date of Survey 5/5/16.
- 4. For grading and additional bench mark and datum information, see "Roadway Plans".
- 5. RIGHT WWLOL's are concrentric with back of sidewalk, see "Roadway Plans". LEFT WWLOL's are parallel with "G" line, and 1" to the right of "G" Line, see "ABUTMENT LAYOUT" sheet and  $\frac{A}{S7}$
- 6. Exist pedestrian bridge must be removed after the construction of widening and barrier replacement is complete. The Contractor will be responsible of disposing the pedestrian bridge.
- 7. Shoring may be required. If determined to be required, submit shop drawings per the specifications.

LEGEND:

Indicates Bottom of Abutment Elevation


Indicates CIDH Pile

Indicates Direction of Creek Flow Indicates Existing Structure


Indicates Bridge Removal (Portion)

Indicates Removal of Exist Pedestrian Bridge, see Note 6

Rev:

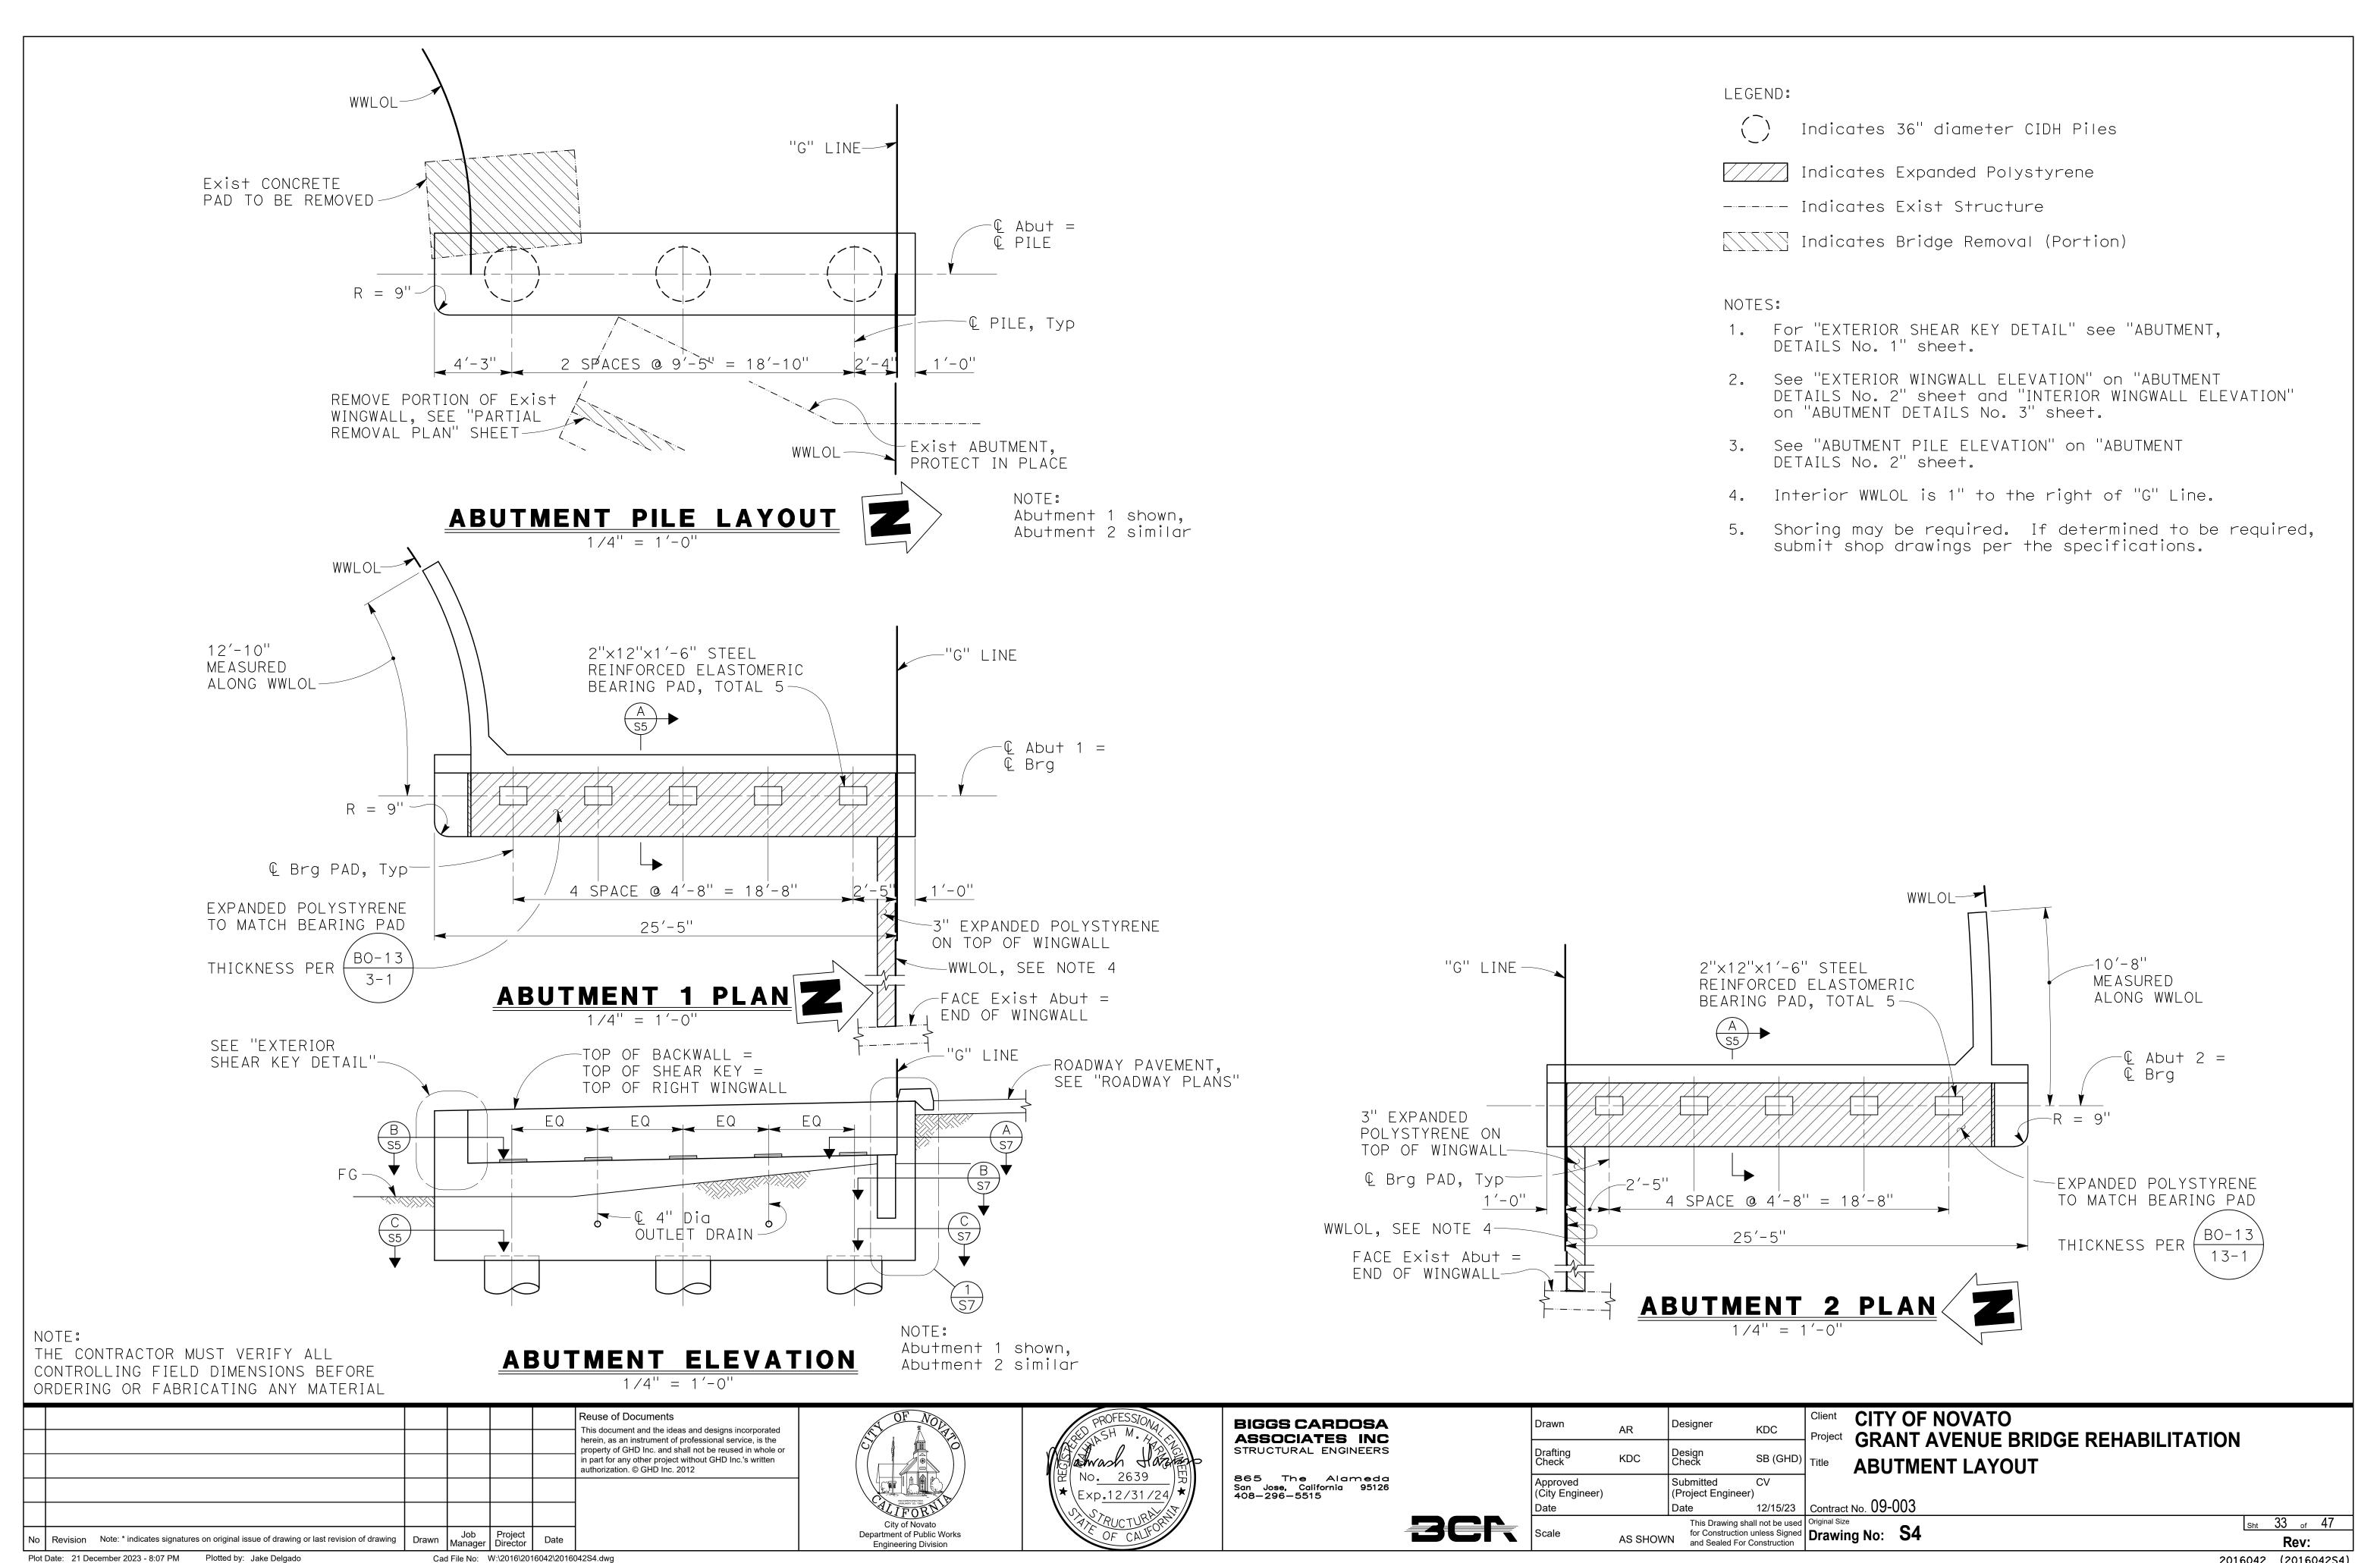


2016042 (201604254)

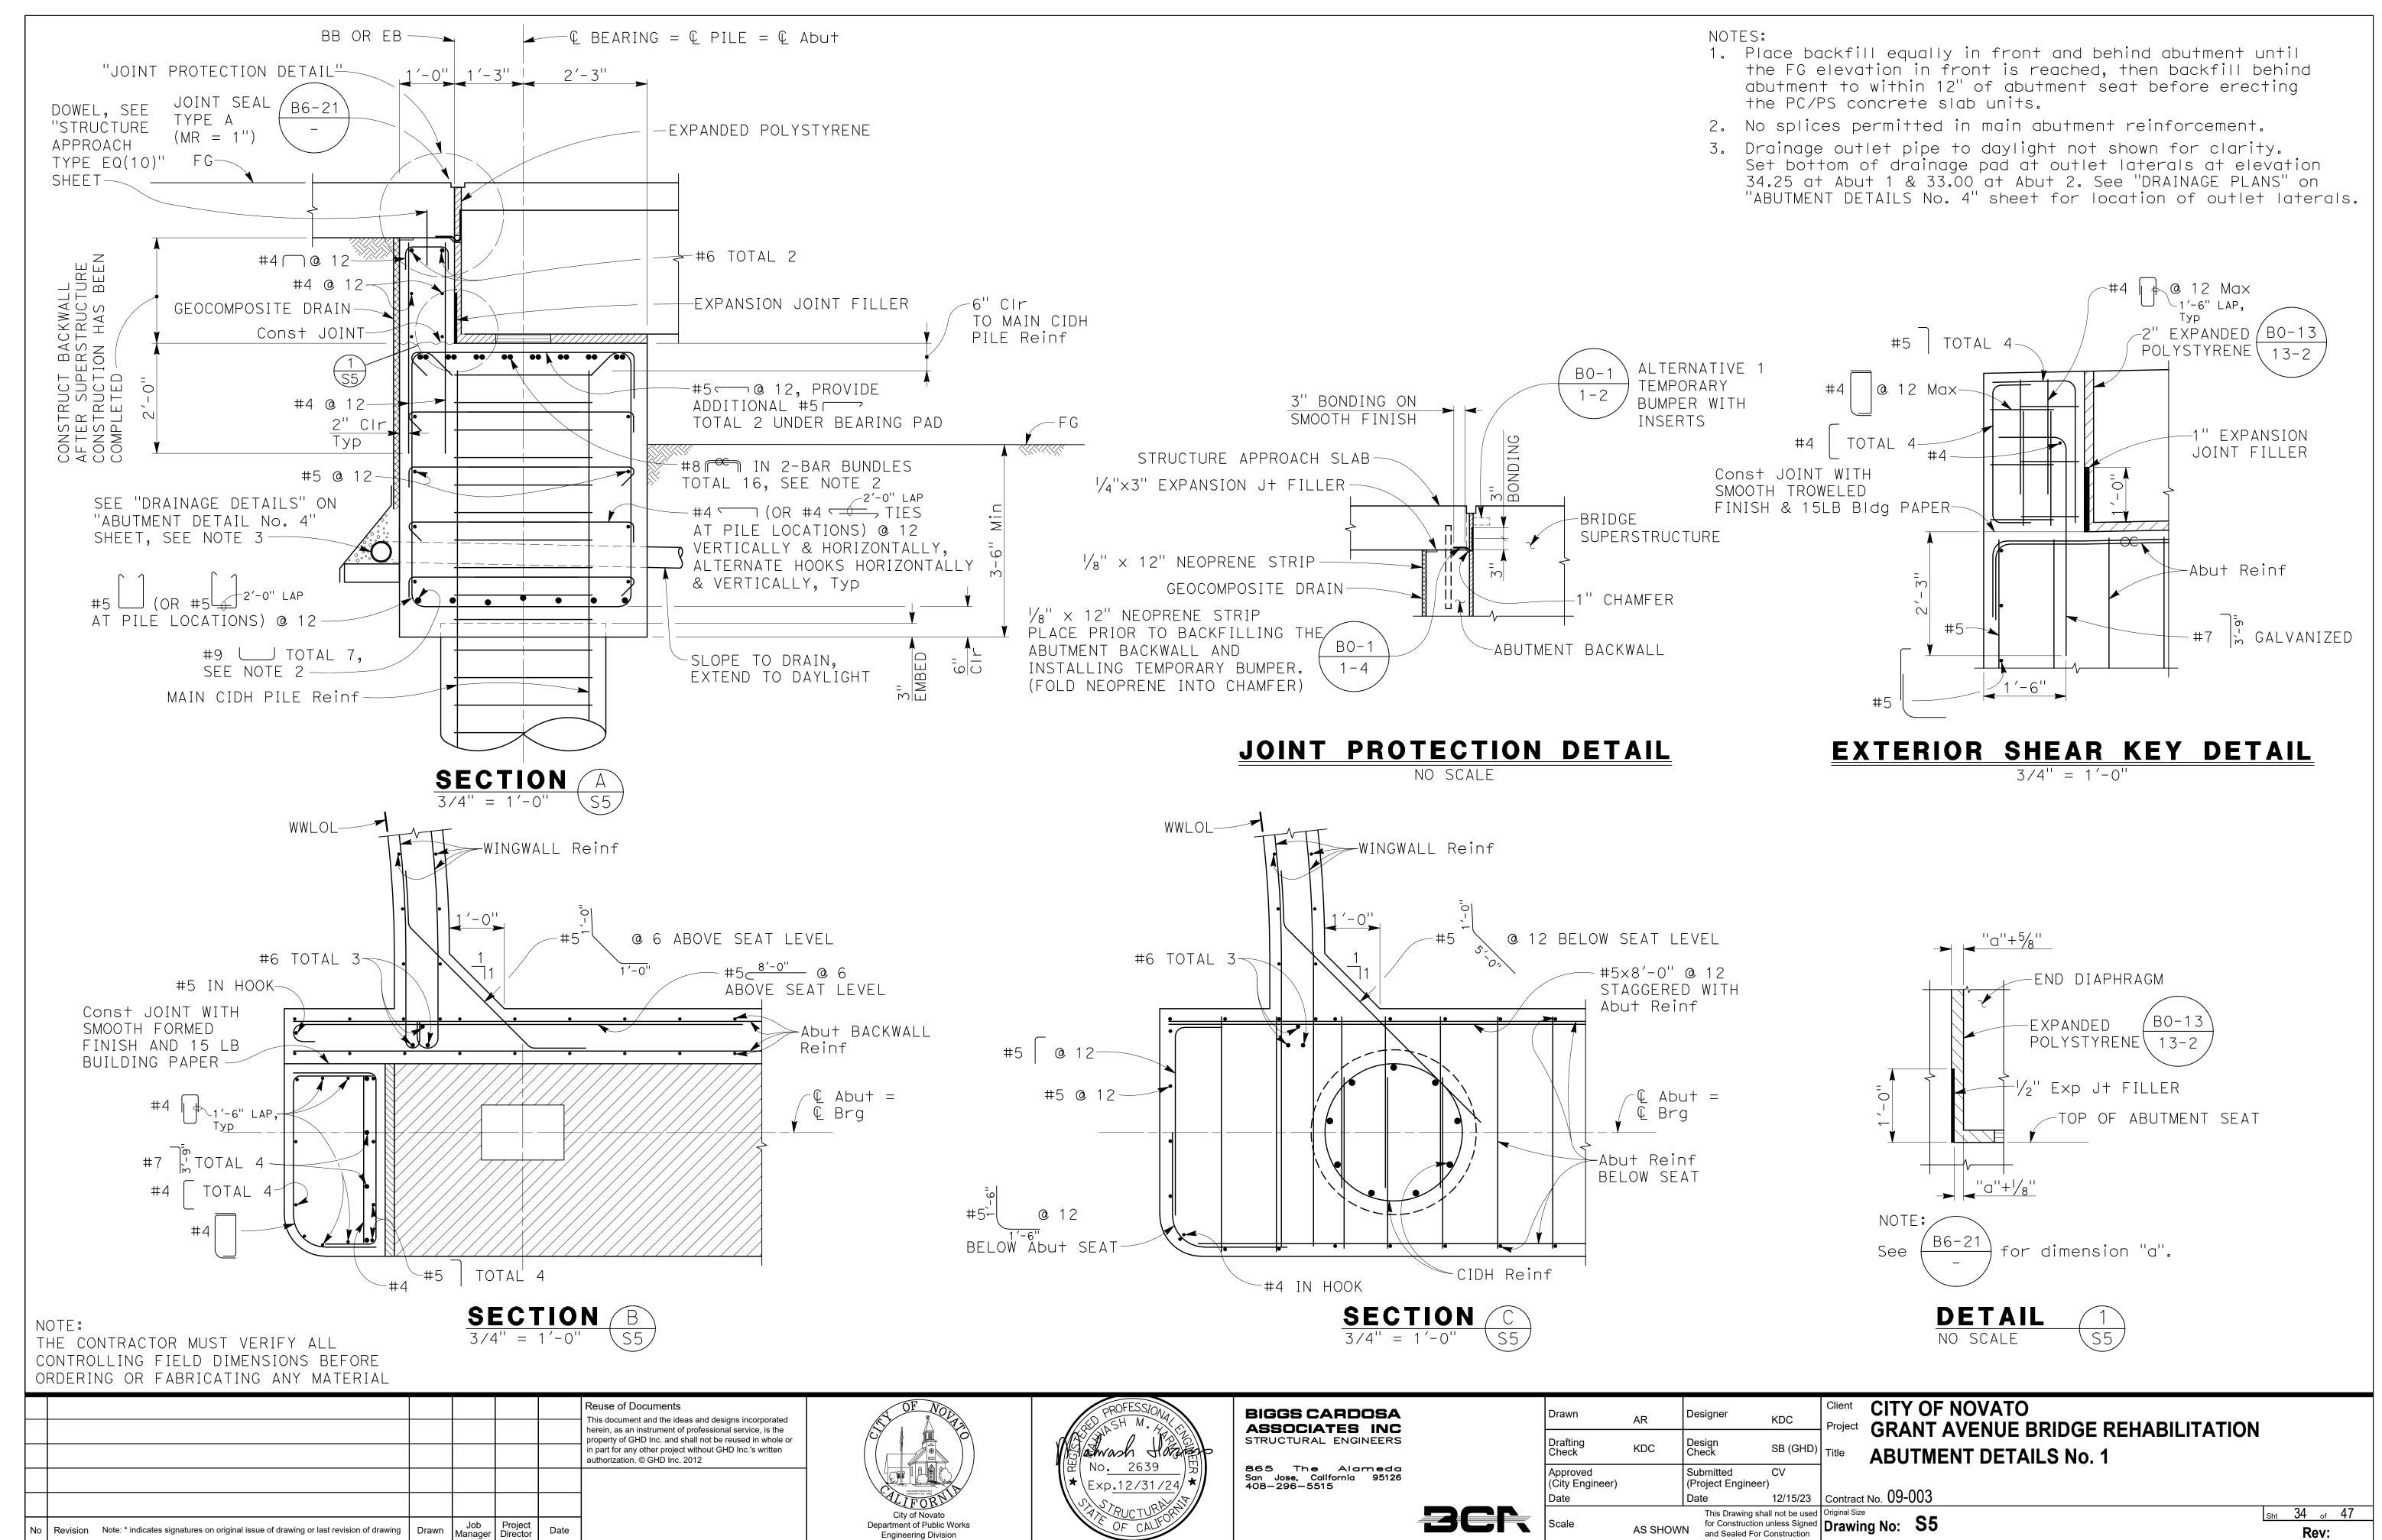


Plot Date: 21 December 2023 - 8:08 PM Plotted by: Jake Delgado

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2016042 (201604255)

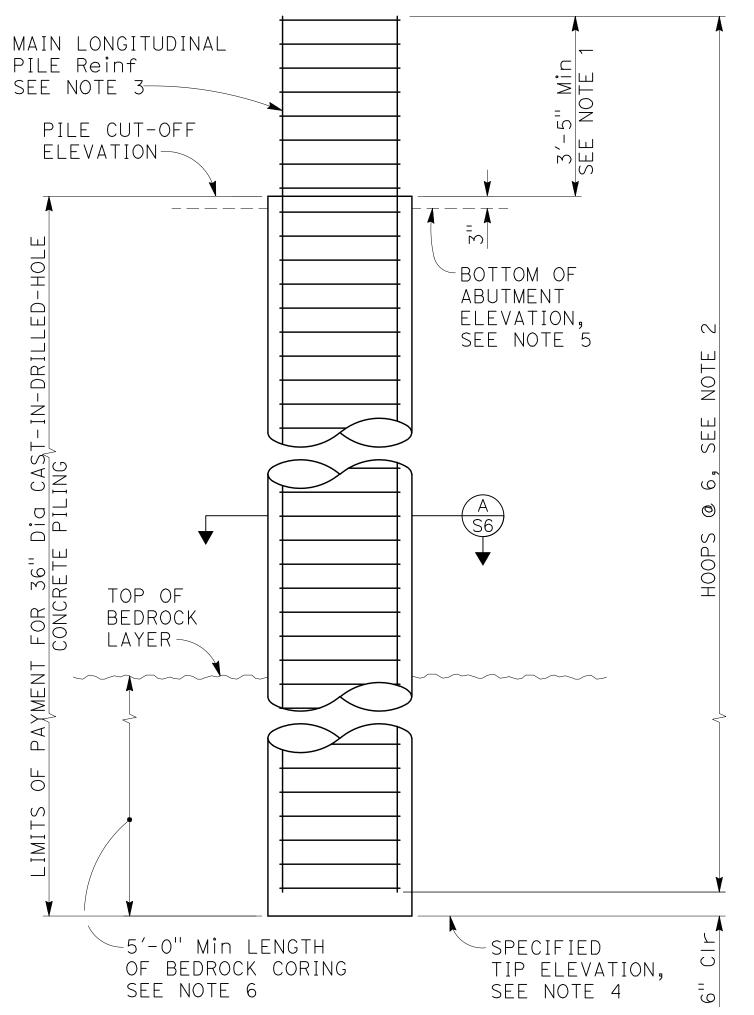

# ABUTMENT PILE ELEVATION 1/2" = 1'-0"

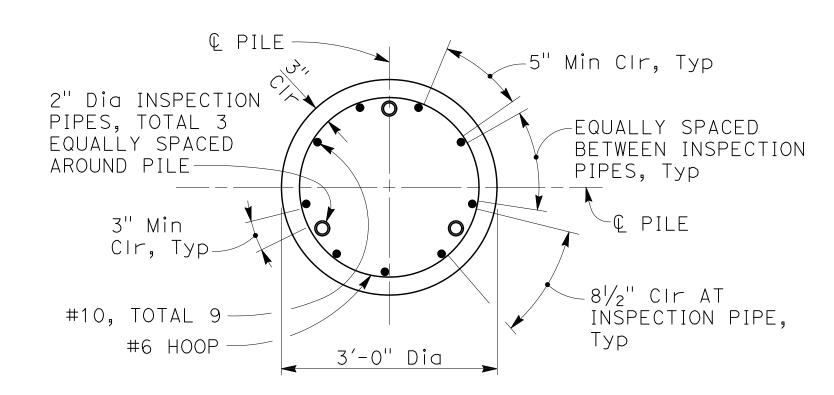

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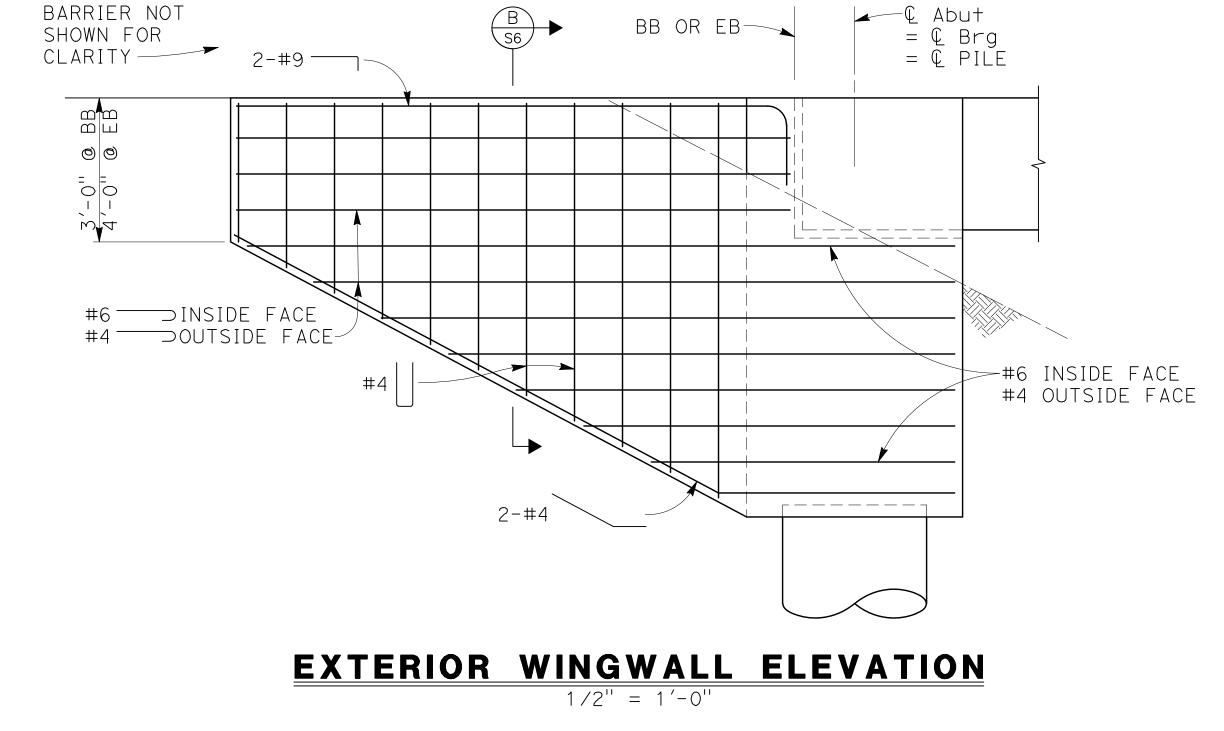
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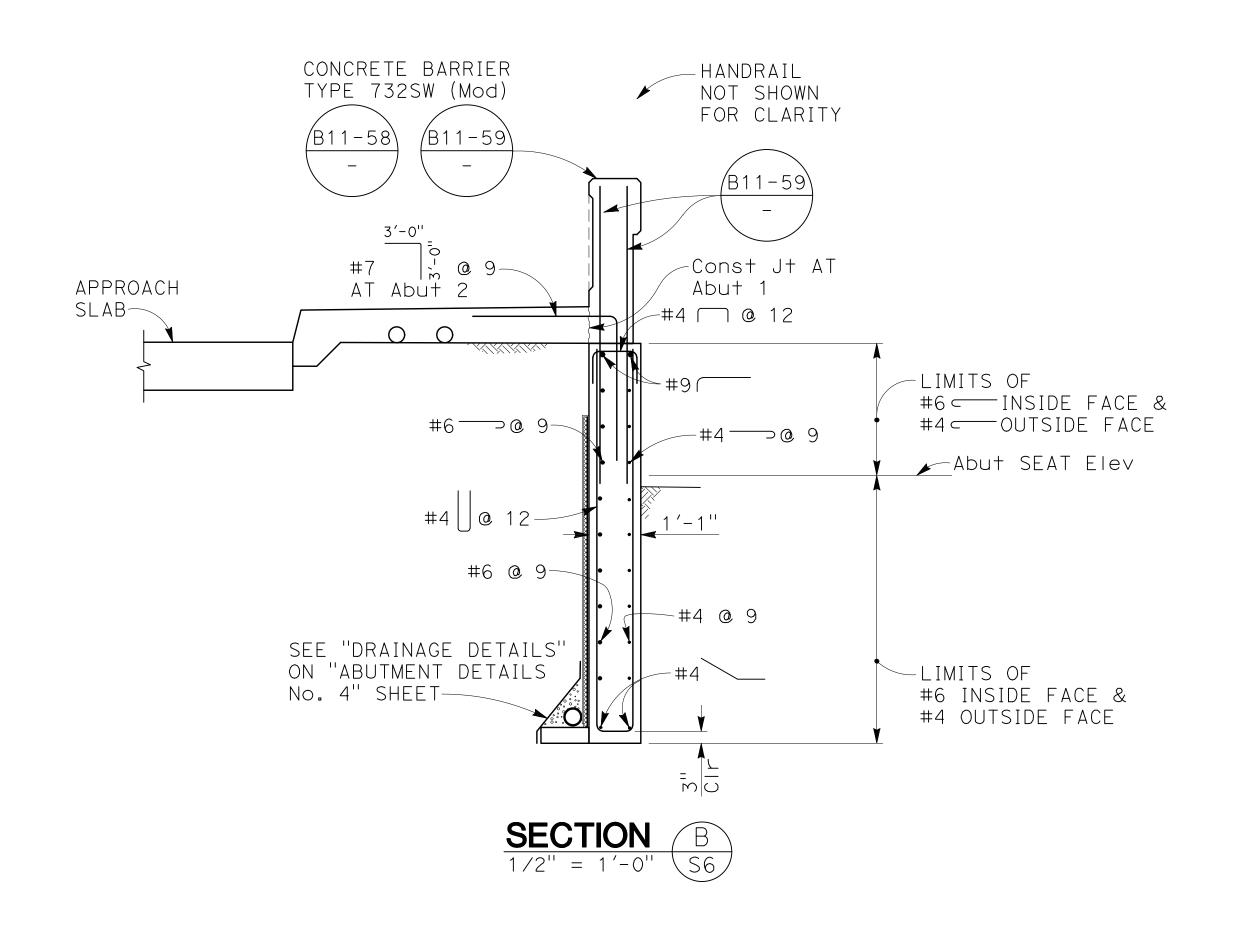
NOTE:
THE CONTRACTOR MUST VERIFY ALL
CONTROLLING FIELD DIMENSIONS BEFORE


ORDERING OR FABRICATING ANY MATERIAL



# NOTES:

- 1. Extend main longitudinal pile reinforcement until 6" clear cover to seat level is achieved.
- 2. All pile hoops must utilize ultimate butt splices.
- 3. No splice allowed in main longitudinal pile reinforcement.
- 4. See "PILE DATA TABLE" on "FOUNDATION PLAN" sheet for specified tip elevations.
- 5. For bottom of abutment elevation, see "FOUNDATION PLAN" sheet.
- 6. Piles must satisfy minimum lengths of bedrock coring shown on this sheet regardless of specified tip elev. Top of bedrock elevations to be determined by test borings per project specifications. Estimated bedrock elevation on sheet S3 shown for bidding purposed only.



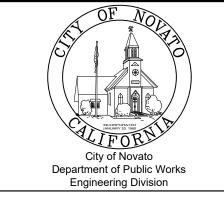



BIGGS CARDOSA ASSOCIATES INC STRUCTURAL ENGINEERS

865 The Alameda San Jose, California 95126 408–296–5515

Scale Scale

Drawn	SMH	Designer	KDC	Clie Proi
Drafting Check	KDC	Design Check	SB (GHD)	Title
Approved (City Engineer)		Submitted (Project Engineer)	CV	
Date		Date	12/15/23	Con

Client CITY OF NOVATO
Project GRANT AVENUE BRIDGE REHABILITATION
Title ABUTMENT DETAILS No. 2

23 Contract No. 09-003

This Drawing shall not be used for Construction unless Signed and Sealed For Construction

This Drawing Signed and Sealed For Construction


This Drawing Size Sealed For Construction Unless Signed and Sealed For Construction


This Drawing Size Sealed For Construction

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2016042 (201604256)



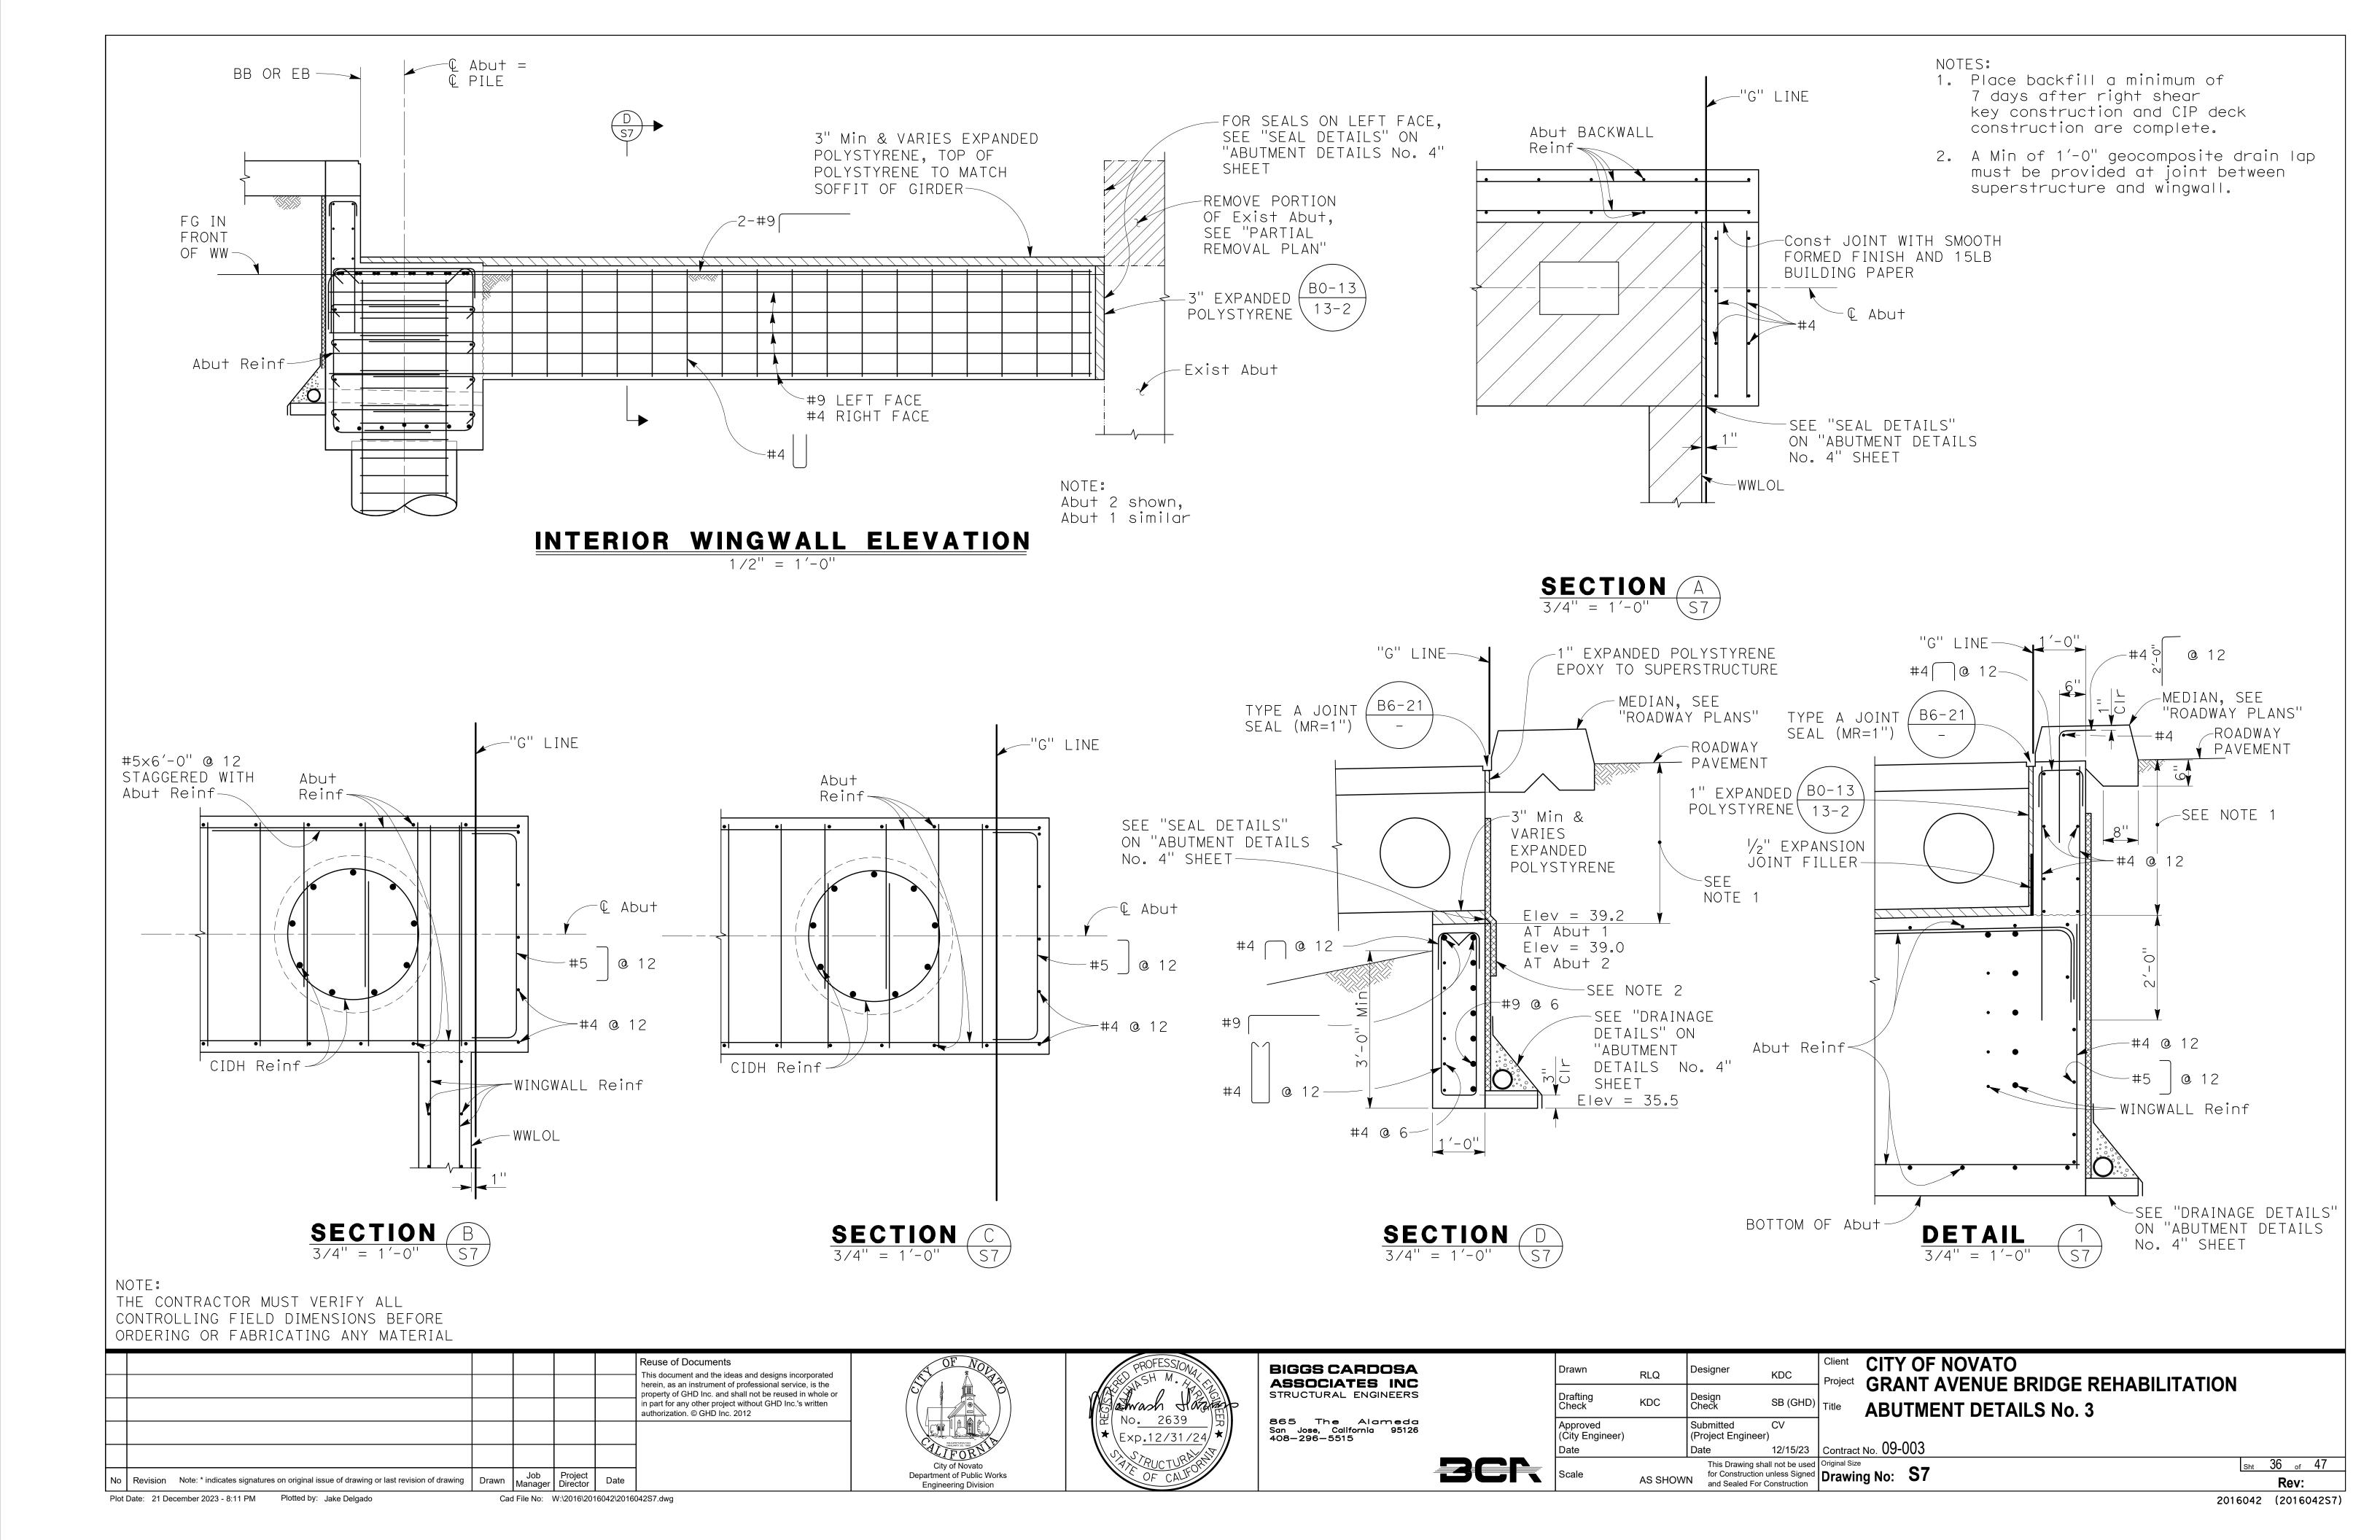

INTERIOR WALL-SUPERSTRUCTURE

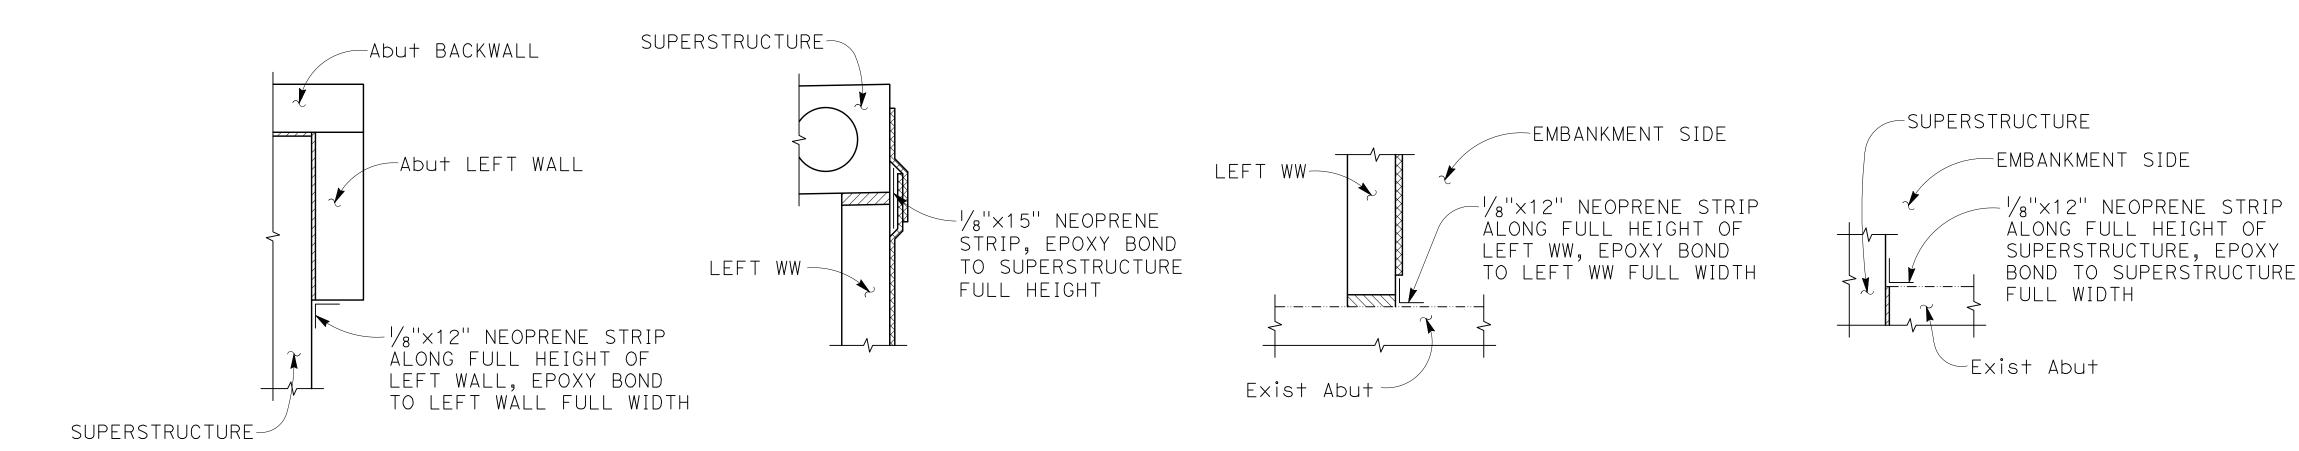
INTERIOR WW-SUPERSTRUCTURE

<u>interior wall-existing abutment</u>

SUPERSTRUCTURE-EXISTING ABUTMENT


# SEAL DETAILS


NO SCALE

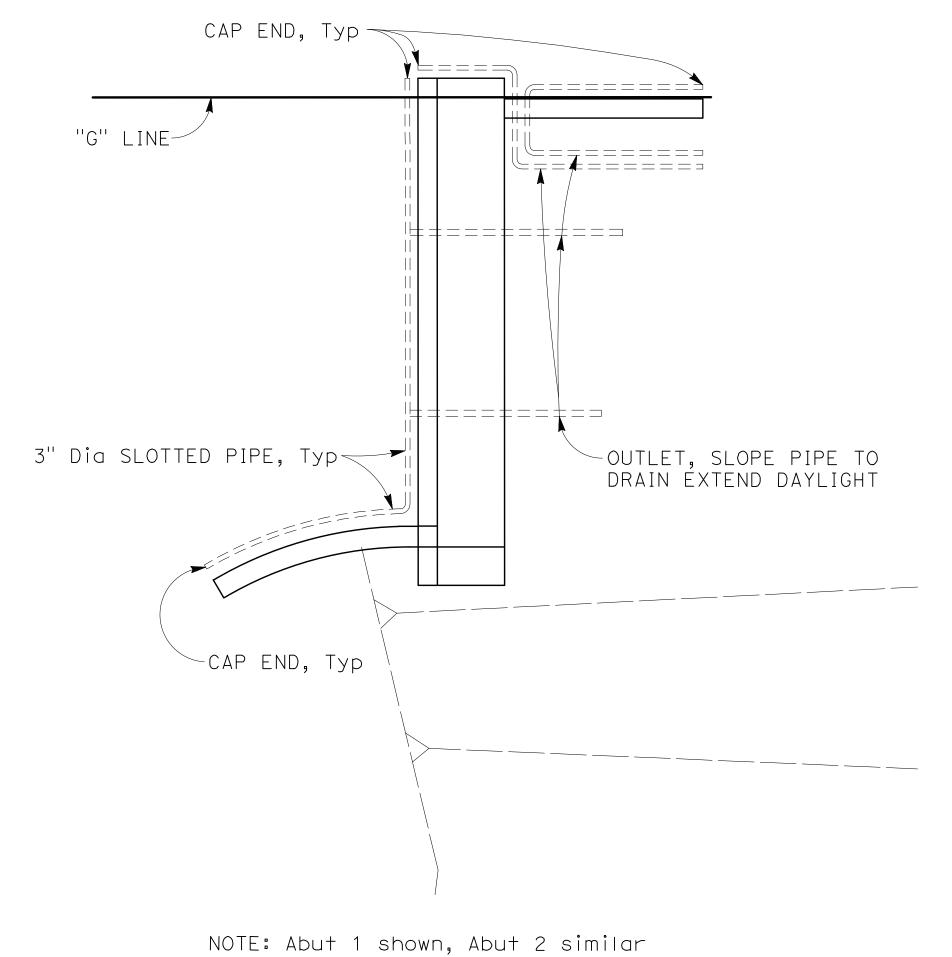





NOTE: THE CONTRACTOR MUST VERIFY ALL CONTROLLING FIELD DIMENSIONS BEFORE ORDERING OR FABRICATING ANY MATERIAL

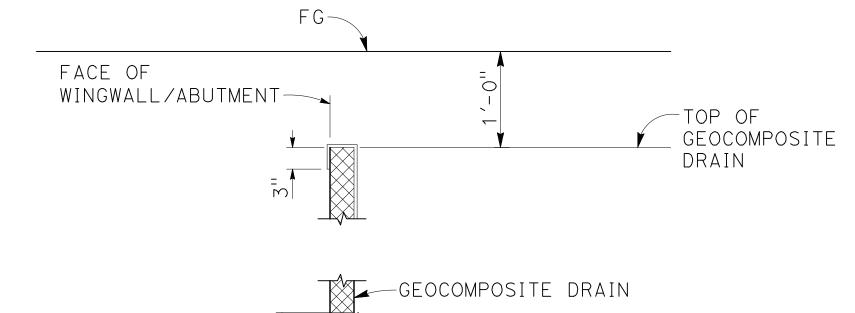

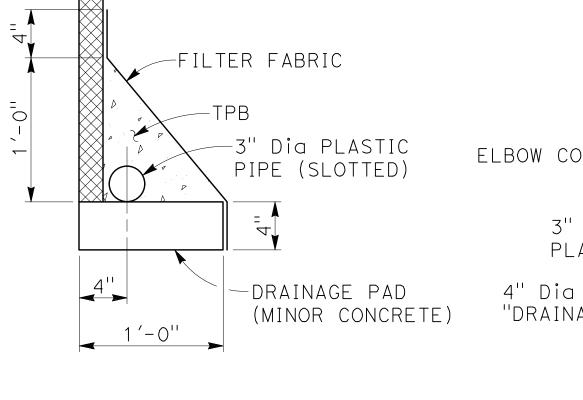

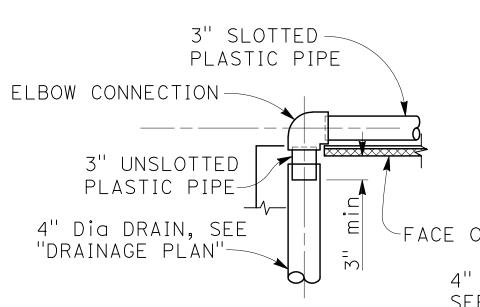

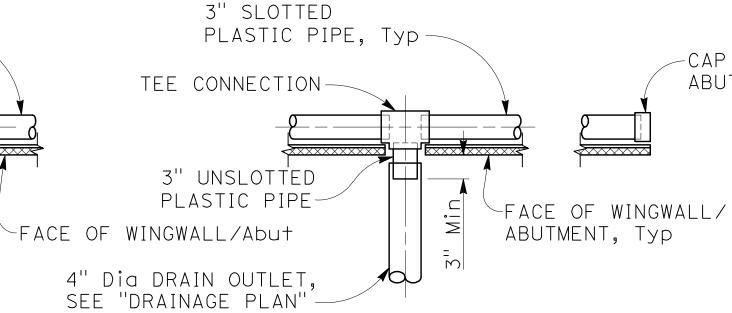

<u>PLAN</u>

Geocomposite drain, cement treated permeable base, and 3" dia slotted plastic pipe continuous behind wingwall and abutment. Cap ends of pipe. Provide "Tee" or elbow connection at each 4" dia drain.

# DRAINAGE DETAIL

NO SCALE

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City of Novato
Department of Public Works
Engineering Division



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865 The Alameda San Jose, California 95126 408–296–5515

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	Date
3CK	Scale

Drawn	RLQ	Designer	KDC	
Drafting Check	KDC	Design Check	SB (GHD)	
Approved (City Engineer)		Submitted (Project Engineer)	CV	
Date		Date	12/15/23	1

Client CITY OF NOVATO
Project GRANT AVENUE BRIDGE REHABILITATION
Title ABUTMENT DETAILS No. 4

Submitted CV (Project Engineer)

Date 12/15/23 Contract No. 09-003

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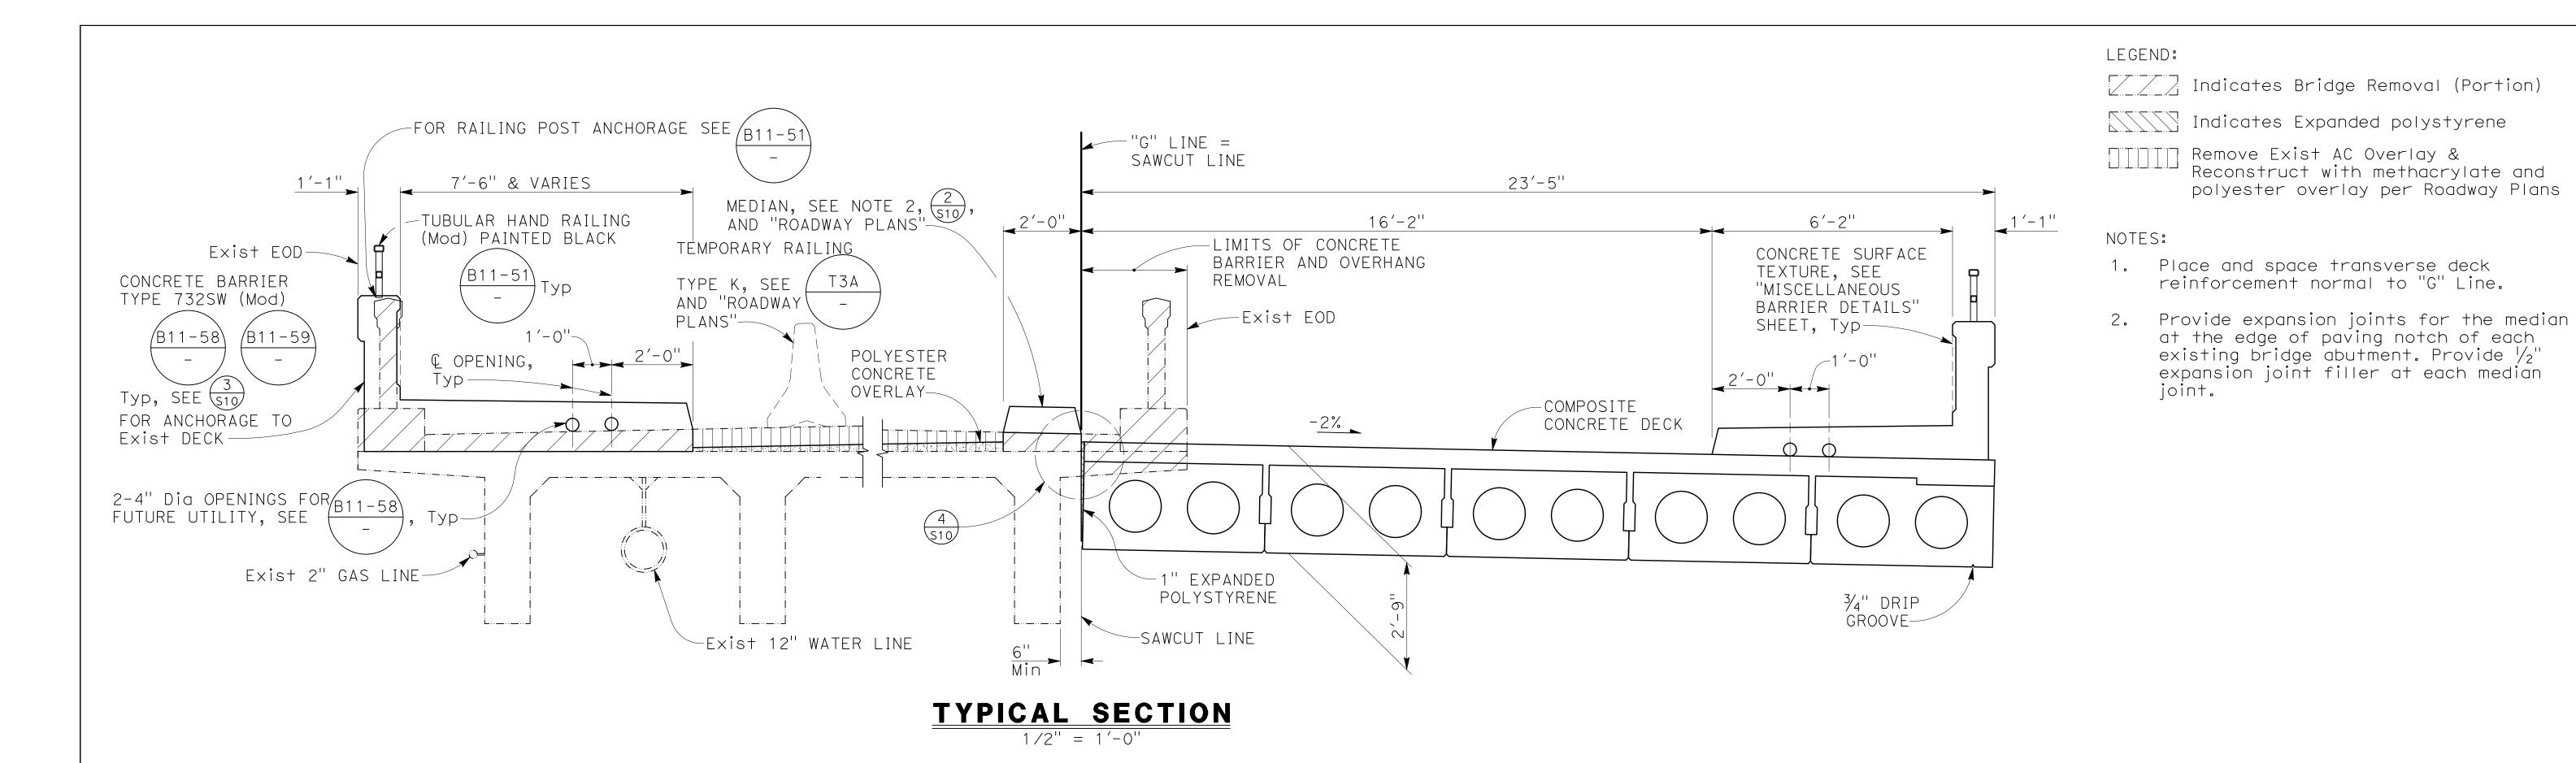
Original Size Drawing No: \$8


Sht 37 of 47 Rev:

2016042 (201604258)

CAP AT END OF ABUTMENT, Typ


SECTION




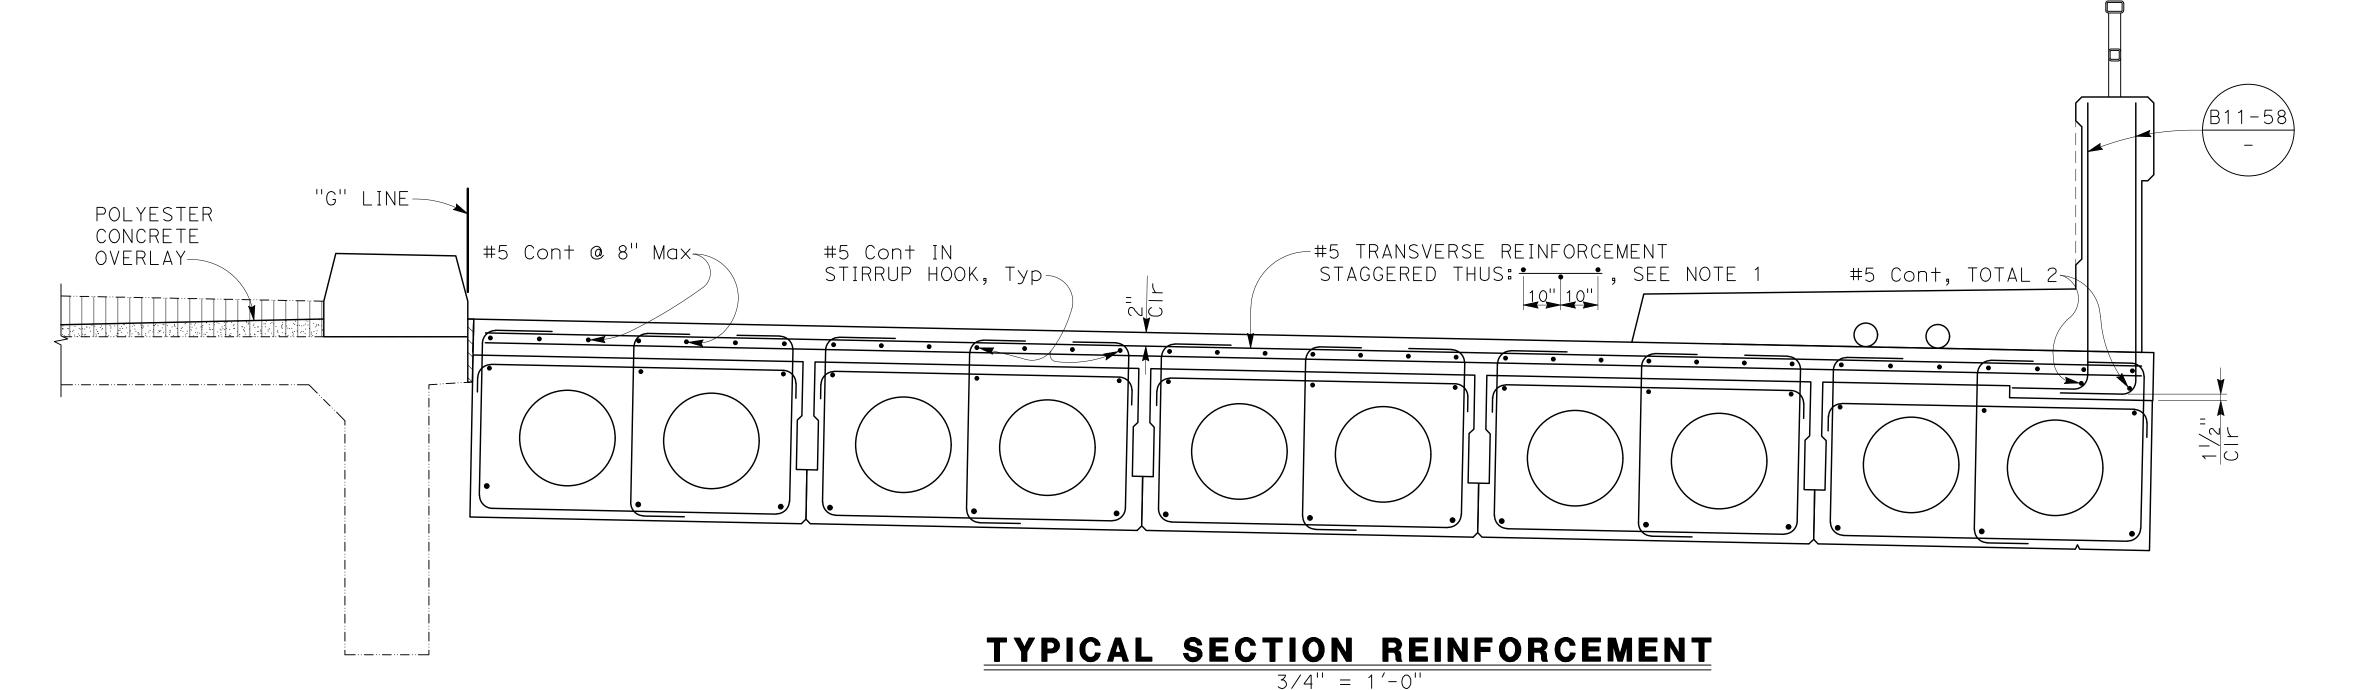

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Date		Date	12/15/23	Cor
Scale	AS SHOW	This Drawing sha	ınless Signed	Origin

Client CITY OF NOVATO Project GRANT AVENUE BRIDGE REHABILITATION **TYPICAL SECTION No. 1** 

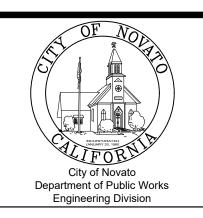contract No. 09-003 This Drawing shall not be used for Construction unless Signed and Sealed For Construction

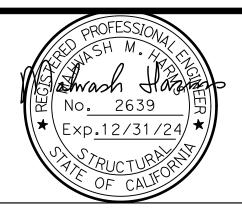Original Size

Drawing No: \$9


Remove Exist AC Overlay &

Reconstruct with methacrylate and

polyester overlay per Roadway Plans


Sht 38 of 47

Rev:

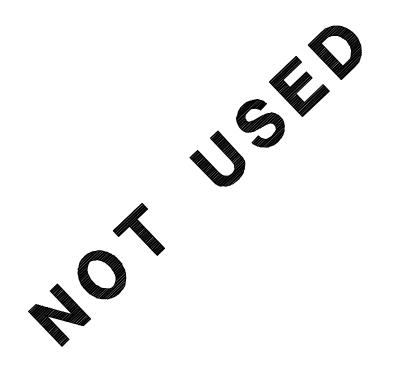

**DETAIL** 


NO SCALE

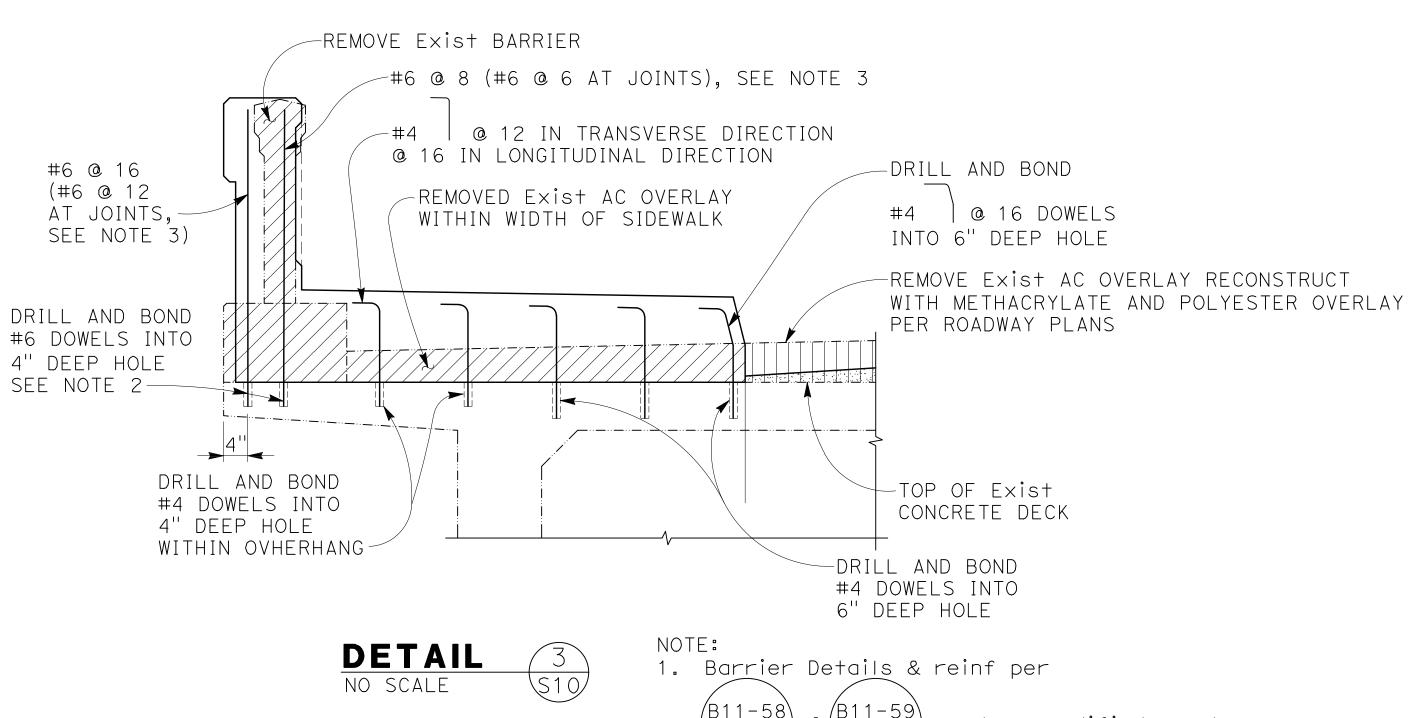



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2. Provide 4" minimum edge distance for first drill & bond dowel adjacent to joint.

3. For Limits of reinforcement at joints, see



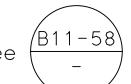

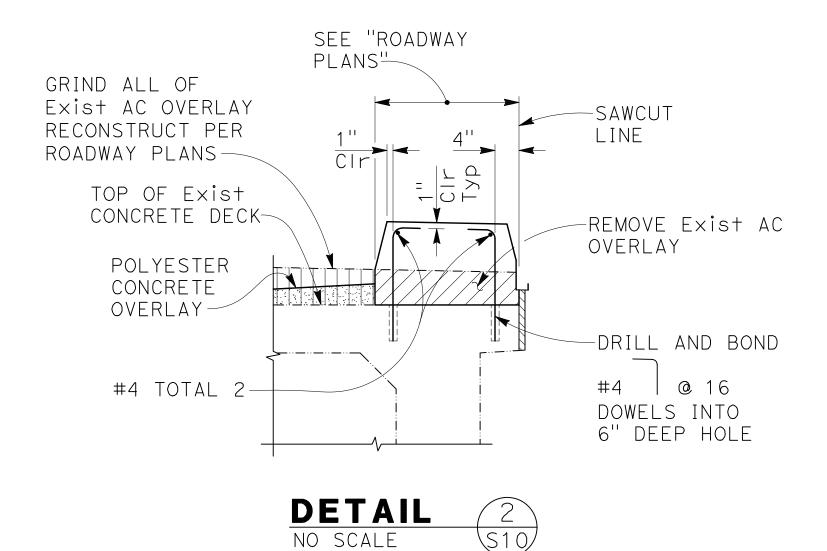

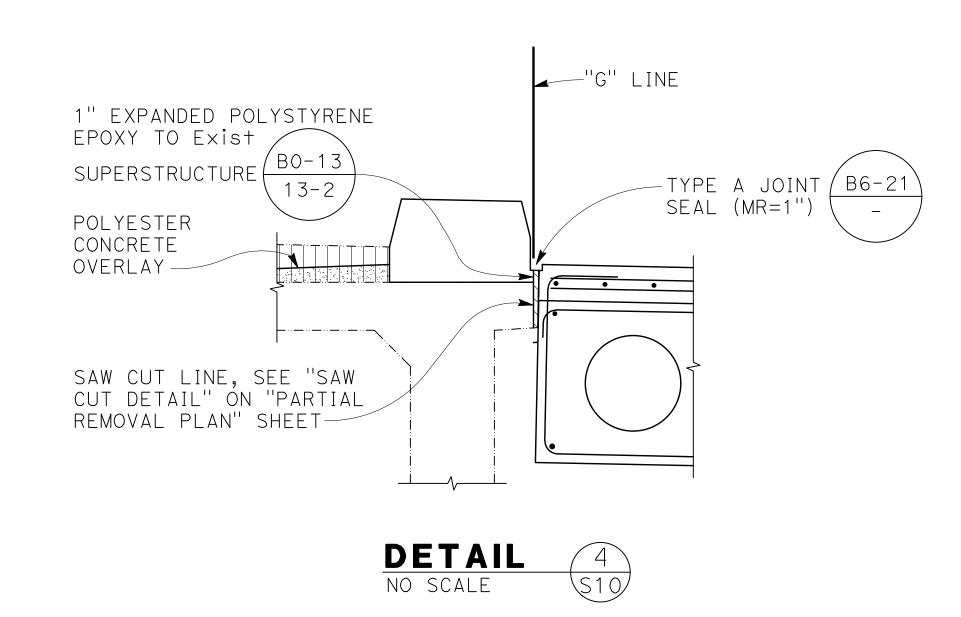
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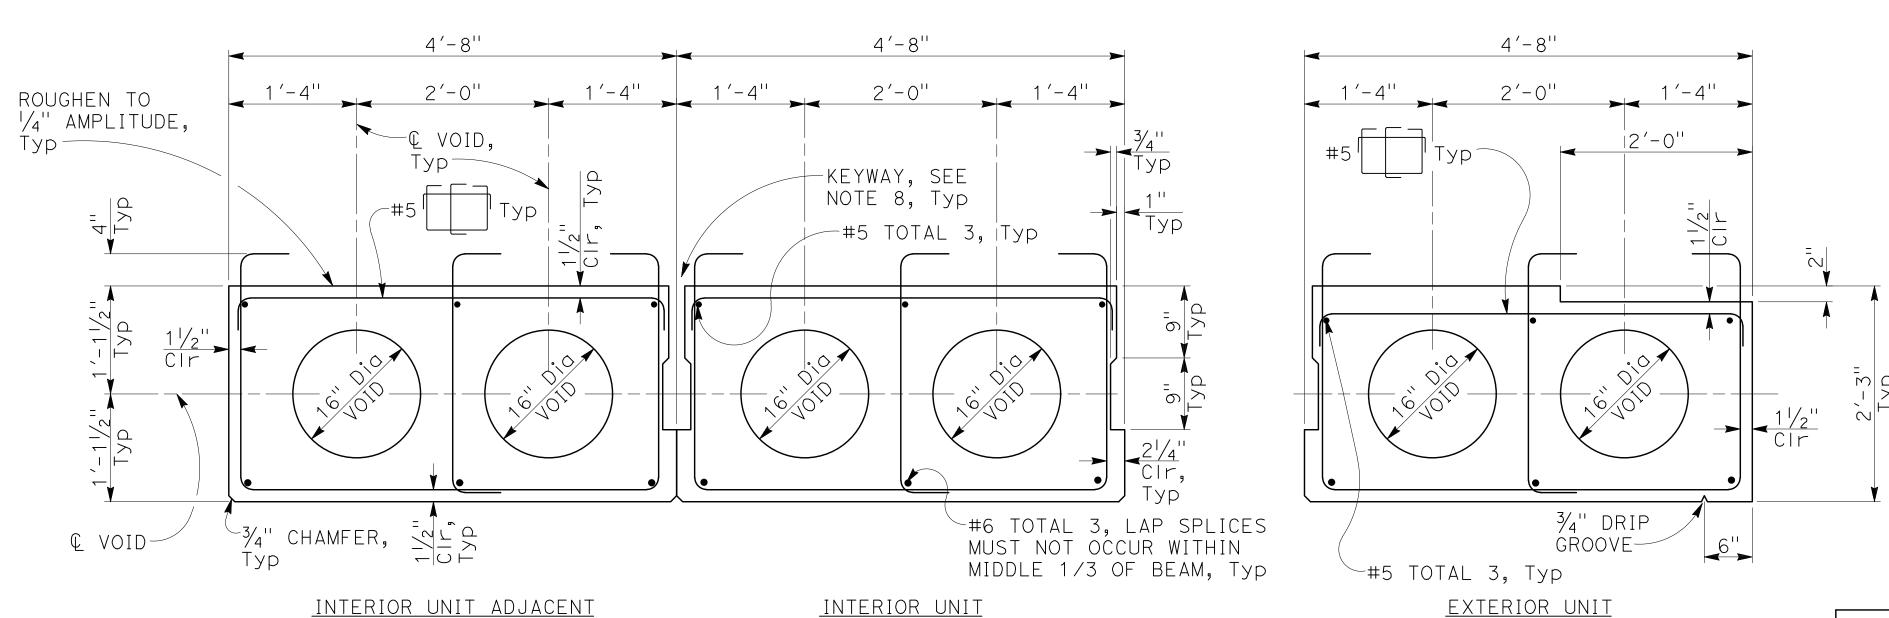
Designer

**CITY OF NOVATO GRANT AVENUE BRIDGE REHABILITATION TYPICAL SECTION No. 2** 


KDC

Sht 39 of 47 Rev:

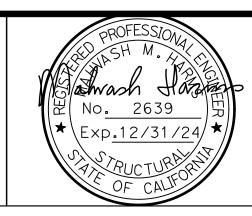
Plot Date: 21 December 2023 - 8:14 PM Plotted by: Jake Delgado Cad File No: W:\2016\2016042\2016042S10.dwg 2016042 (2016042\$10)



# PRECAST/PRESTRESSED CONCRETE SLAB UNIT

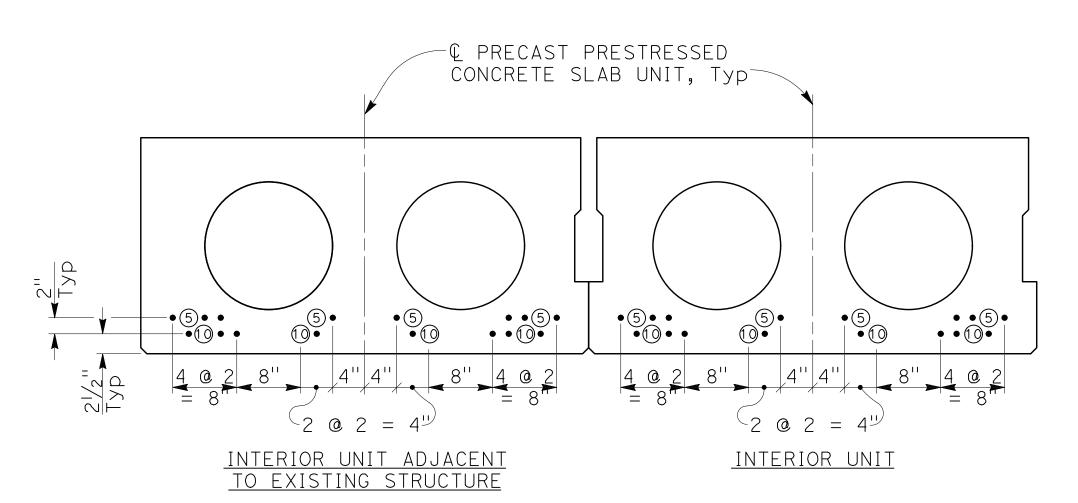

TO EXISTING STRUCTURE

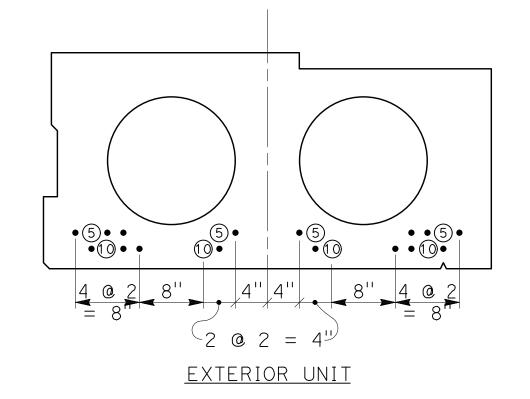

# STRAND LAYOUT

# LEGEND:

- Denotes continuously bonded strand.
- (5) Denotes debonded strand and debonded length in feet, measured from the ends of the Precast Prestressed Concrete Slab Unit.


PRESTRESSING DATA TABLE										
Girder	# Units	Pjack (k/unit)	No. of P/S strands	Deflection at midspan due to deck DL (in)	Deflection at midspan due to barrier DL (in)					
Interior unit adjacent to existing structure	1	1055	24	0.45	0.17					
Interior unit	3	1055	24	0.49	0.17					
Exterior unit	1	1055	24	0.57	0.17					


# Prestressing Notes

- 1. Pjack is the jacking force required at the point of control along the span. The Jacking force does not include any fabrication specific losses.
- 2. The maximum tensile stress in the prestressing steel upon release must not exceed 75% of the specified minimum ultimate tensile strength of the prestressing steel.
- 3. The maximum temporary tensile stress (jacking stress) in the prestressing steel must not exceed 80% of the specified minimum ultimate tensile strength of the prestressing steel.
- 4. Design based on 270 ksi low relaxation 0.6" dia strand
- 5. Slab designed for pretensioning
- 6. Concrete: f'c = 6 ksi at 28 days f'ci = 4 ksi at Time of stressing
- 7. Total number of precast slab units = 5
- 8. Keyways to be filled with non-shrink grout (ASTM C-1107) minimum of 14 days prior to placement of composite concrete slab.
- 9. Screed line elevations for deck concrete will be determined by Contractor.

NOTE:
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Client CITY OF NOVATO
Project GRANT AVENUE BRIDGE REHABILITATION

Title PRECAST PRESTRESSED CONCRETE
SLAB DETAILS No. 1

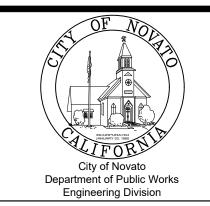Date

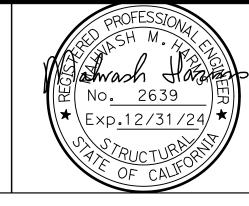Date

Date

Date

Date

12/15/23


Contract No. 09-003


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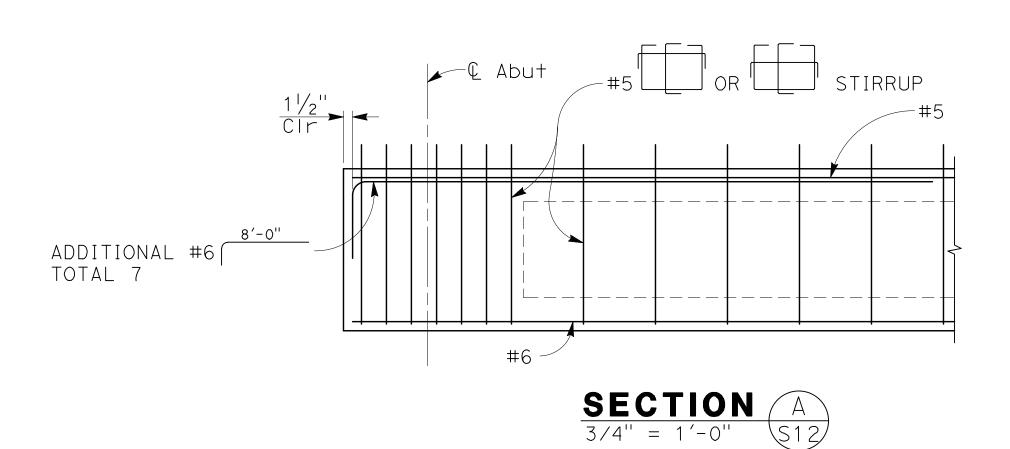
Drawing No: S11

sht 40 of 47 Rev:


2016042 (2016042511)




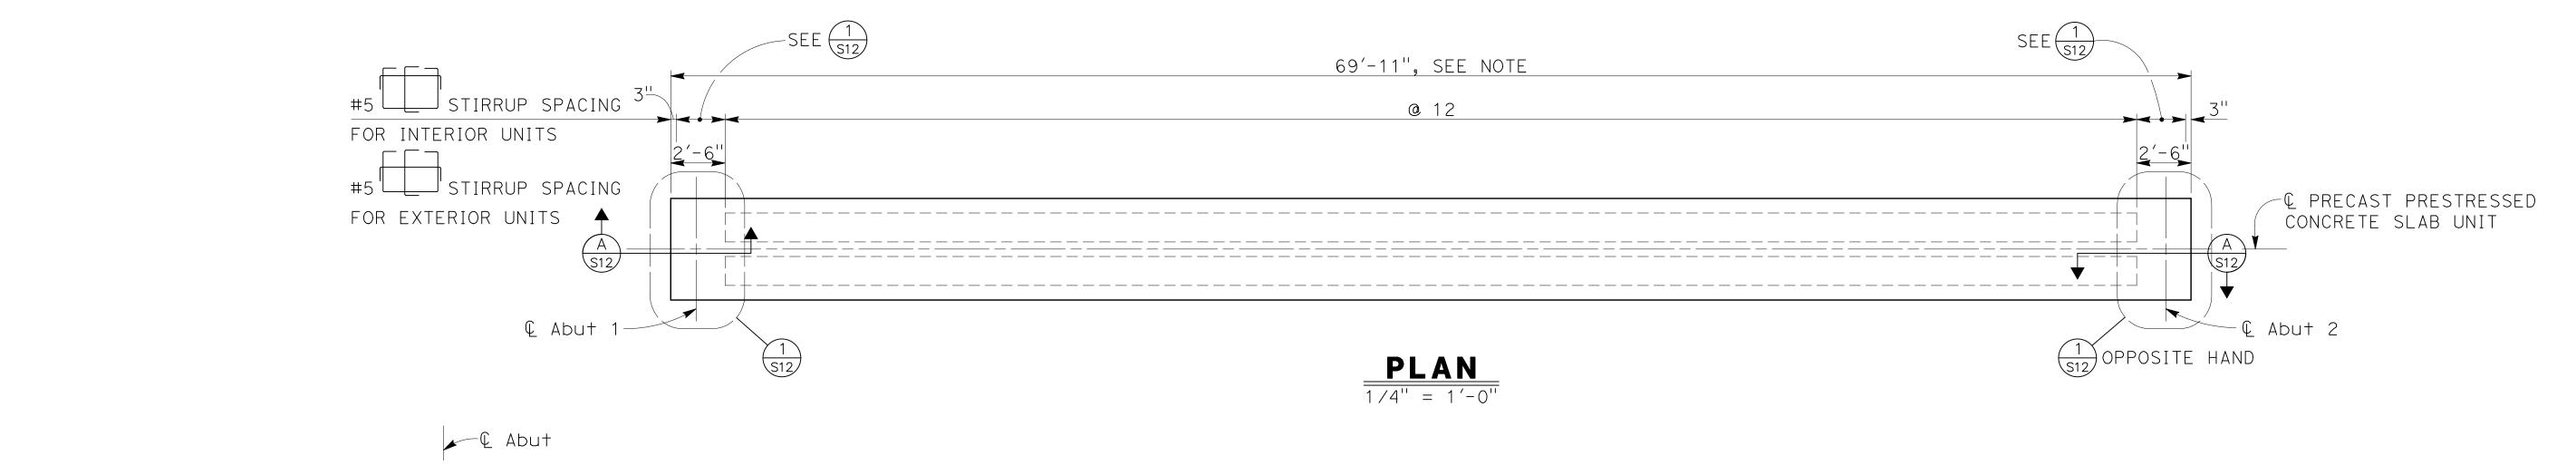

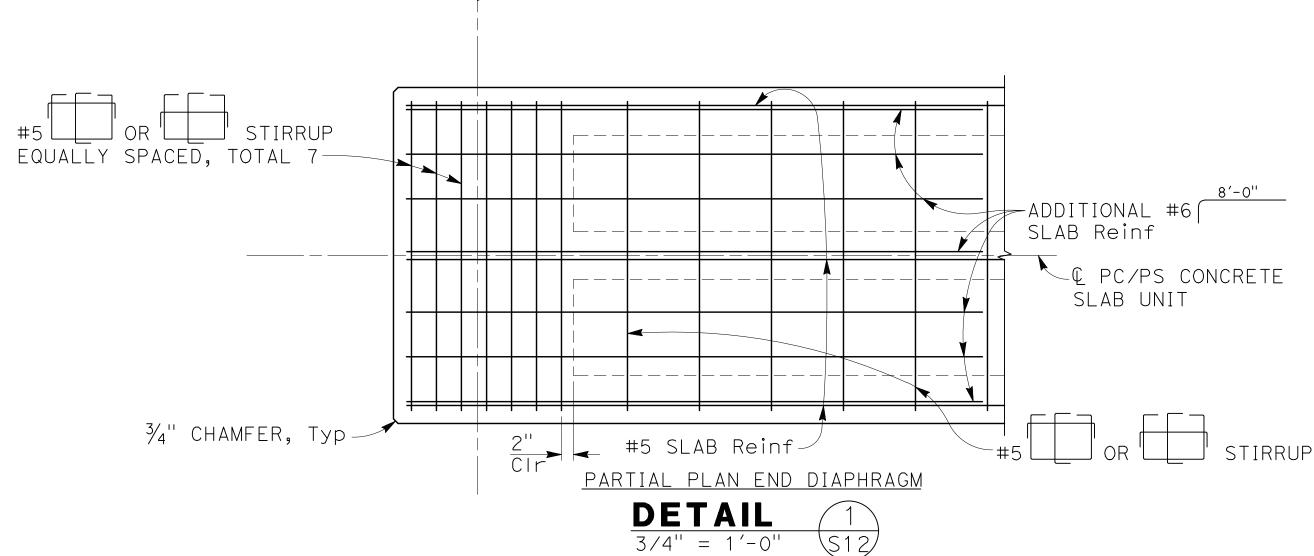

NOTE:
The Contractor shall verify all controlling field dimensions before ordering or fabricating any material

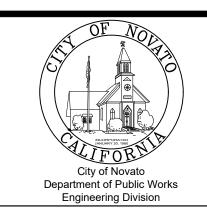

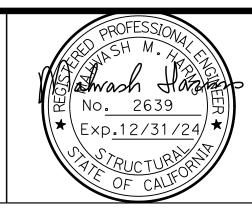

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Approved (City Engineer)		Submitted (Project Engineer)	CV )	
Date		Date	12/15/23	Co
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NOTES:

Client CITY OF NOVATO
Project GRANT AVENUE BRIDGE REHABILITATION

Title PRECAST PRESTRESSED CONCRETE
SLAB DETAILS No. 2

Girder length provided assumes an "a" value of  $\frac{1}{2}$ " for joint seal at abutments. Girder length must be adjusted if "a" value used is different from assumed value.

S12 Sht 41 of 47 Rev:

 2016042 (2016042512)

-Exist BARRIER TO BE REMOVED NOT SHOWN FOR CLARITY —"G" LINE -PROVIDE 1" EXPANDED POLYSTYRENE ALONG Exist EOD VERTICAL SAWCUT SAWCUT LINE, SEE "SAWCUT DETAIL" PROVIDE 2" EXPANDED POLYSTYRENE ALONG HORIZONTAL SAW CUT, TOP OF POLYSTYRENE
TO MATCH SOFFIT OF GIRDER FOR SEAL DETAILS ON EMBANKMENT SIDE, SEE "SEAL DETAILS" ON Elev 39.2 AT Abut 1 Elev 39.0 AT Abut 2 "ABUTMENT DETAILS No. 4" SHEET END OF Exist WINGWALL ANGLE POINT -LIMITS OF OF Exist WW-REMOVAL OF ABUTMENT Exist West WW shown, Exist East WW similar

# **DEVELOPED EXISTING WINGWALL ELEVATION**

REMOVE Exis+ Reinf CROSSING — THE SAW CUT LINE TO 1" BELOW SAWCUT LINE AND FILL HOLES -SAWCUT LINE WITH MORTAR -Exist Reinf NOTES: Horizontal sawcut line shown, vertical saw cut line similar

SAWCUT DETAIL - PLAN

The Contractor shall verify all controlling field dimensions before ordering or fabricating any material

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Date		This Drawing sha		ŀ

LEGEND:


Indicates Bridge Removal (Portion)


Client	CITY OF NOVATO
Project	<b>GRANT AVENUE BRIDGE REHABILITATION</b>
Title	PARTIAL REMOVAL PLAN

Contract No. 09-003


Sht 42 of 47 AS SHOWN AS Sealed For Construction unless Signed and Sealed For Construction Rev:

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SECTION A
NO SCALE \$14

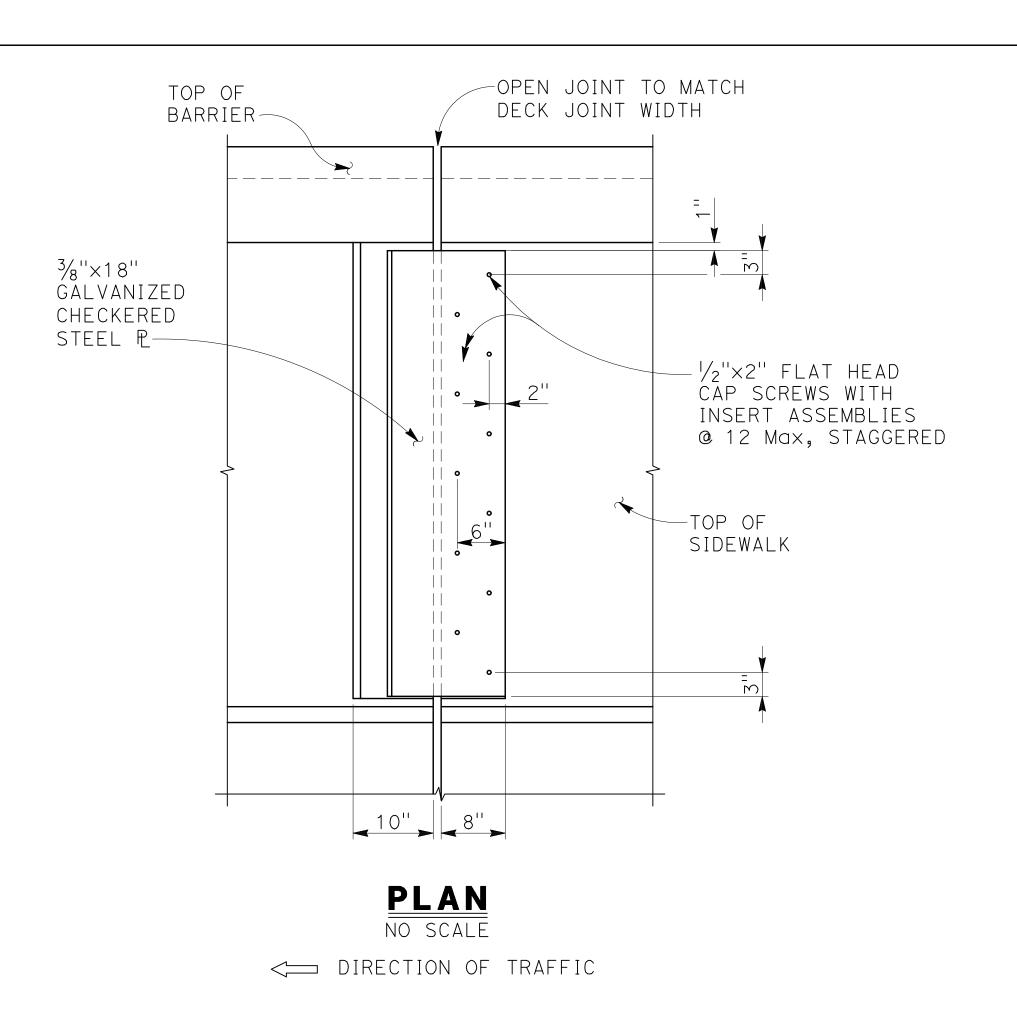


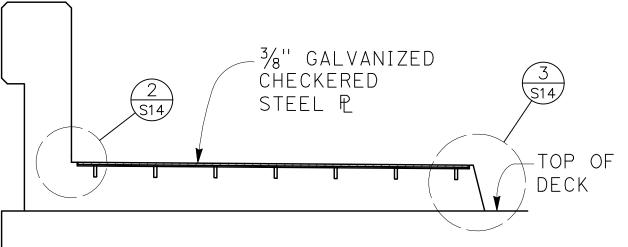
# NOTES:

- Utility openings and expansion joints not shown for clarity.
- 2. Recess concrete  $\frac{1}{2}$ " for plates.
- 3. Plates to be galvanized.
- 4. Architectural treatment on barriers not shown
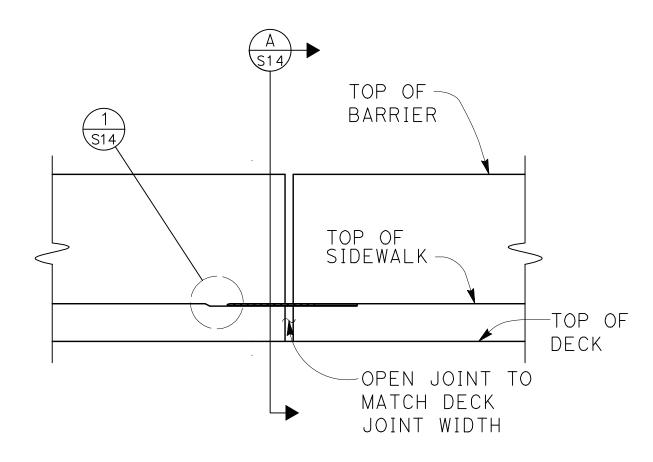
# **ELEVATION**

NO SCALE

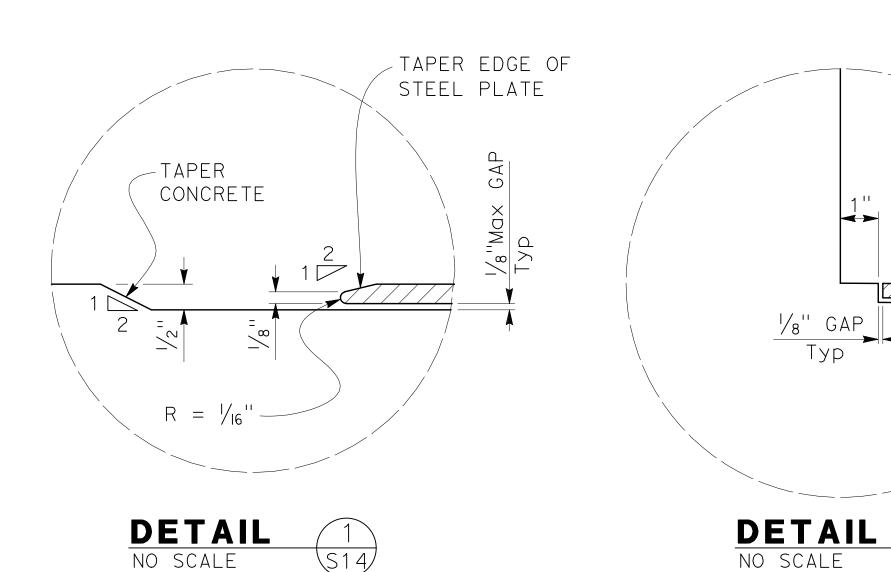


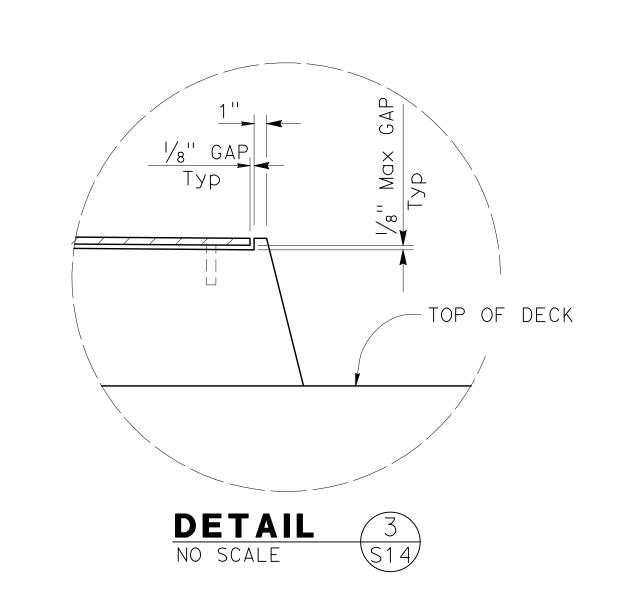

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Date		Date	12/15/23	Cor

S14/

Client CITY OF NOVATO
Project GRANT AVENUE BRIDGE REHABILITATION
Title JOINT ARMOR FOR PEDESTRIAN WALKWAYS

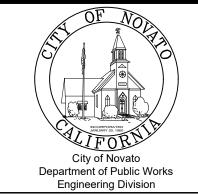Project Engineer)

Date

12/15/23

Contract No. 09-003

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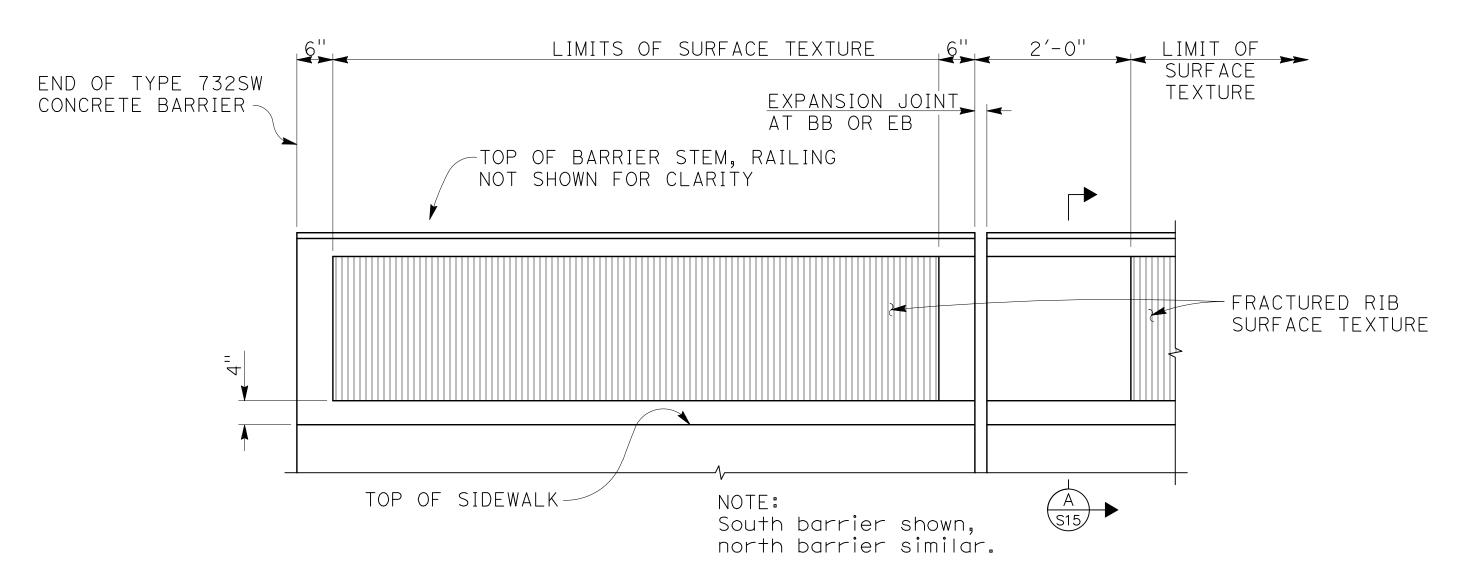
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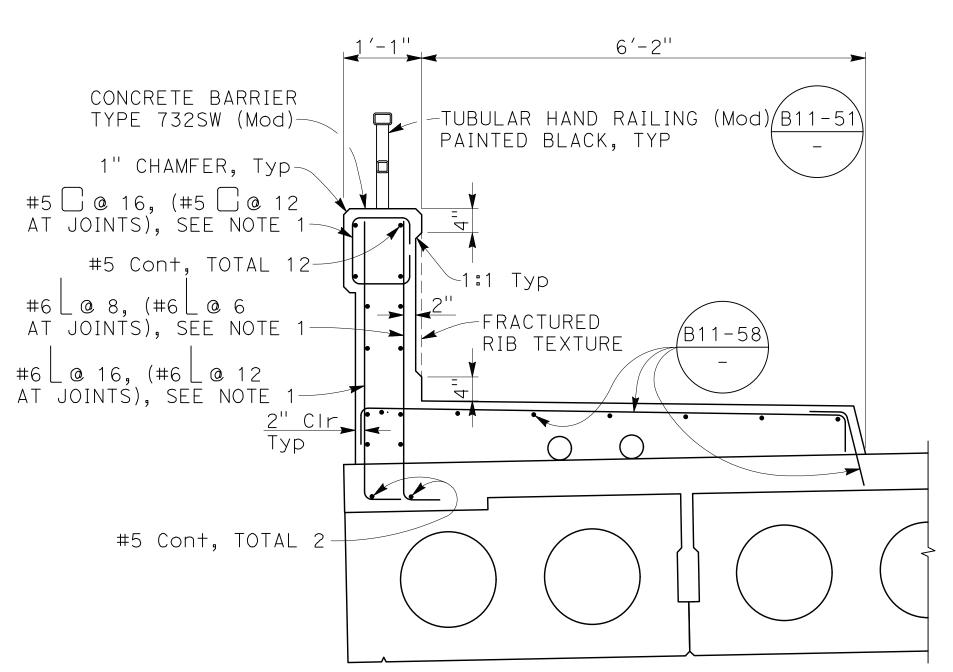
No. 09-003

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Rev:



# BARRIER SURFACE TEXTURE ELEVATION 3/4" = 1'-0"



NOTES:


1. Position to stay clear of additional reinforcement for post pocket

2. Barrier Details & reinf per

, unless modified as shown

3. For Limits of reinforcement at joints, see  $\frac{B11-58}{}$ 



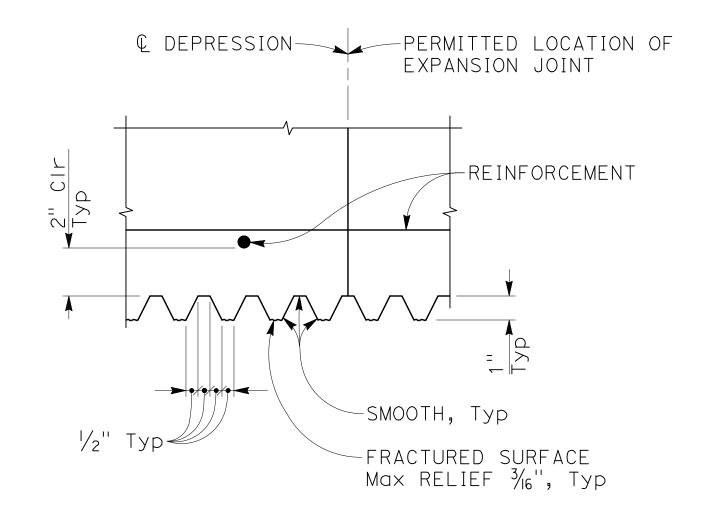



# FRACTURED RIB TEXTURE DETAIL

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afting neck	KDC	Design Check	SB (GHD)		
proved ity Engineer) ate		Submitted (Project Engineer) Date	CV ) 12/15/23	Contract	No. 09-003

AS SHOWN


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This Drawing shall not be used for Construction

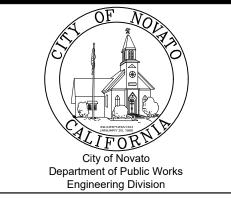
Original Size

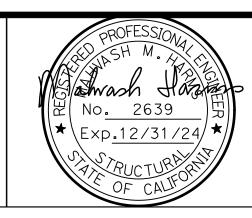Drawing No: \$15 Sht 44 of 47 Rev:


2016042 (2016042\$15)

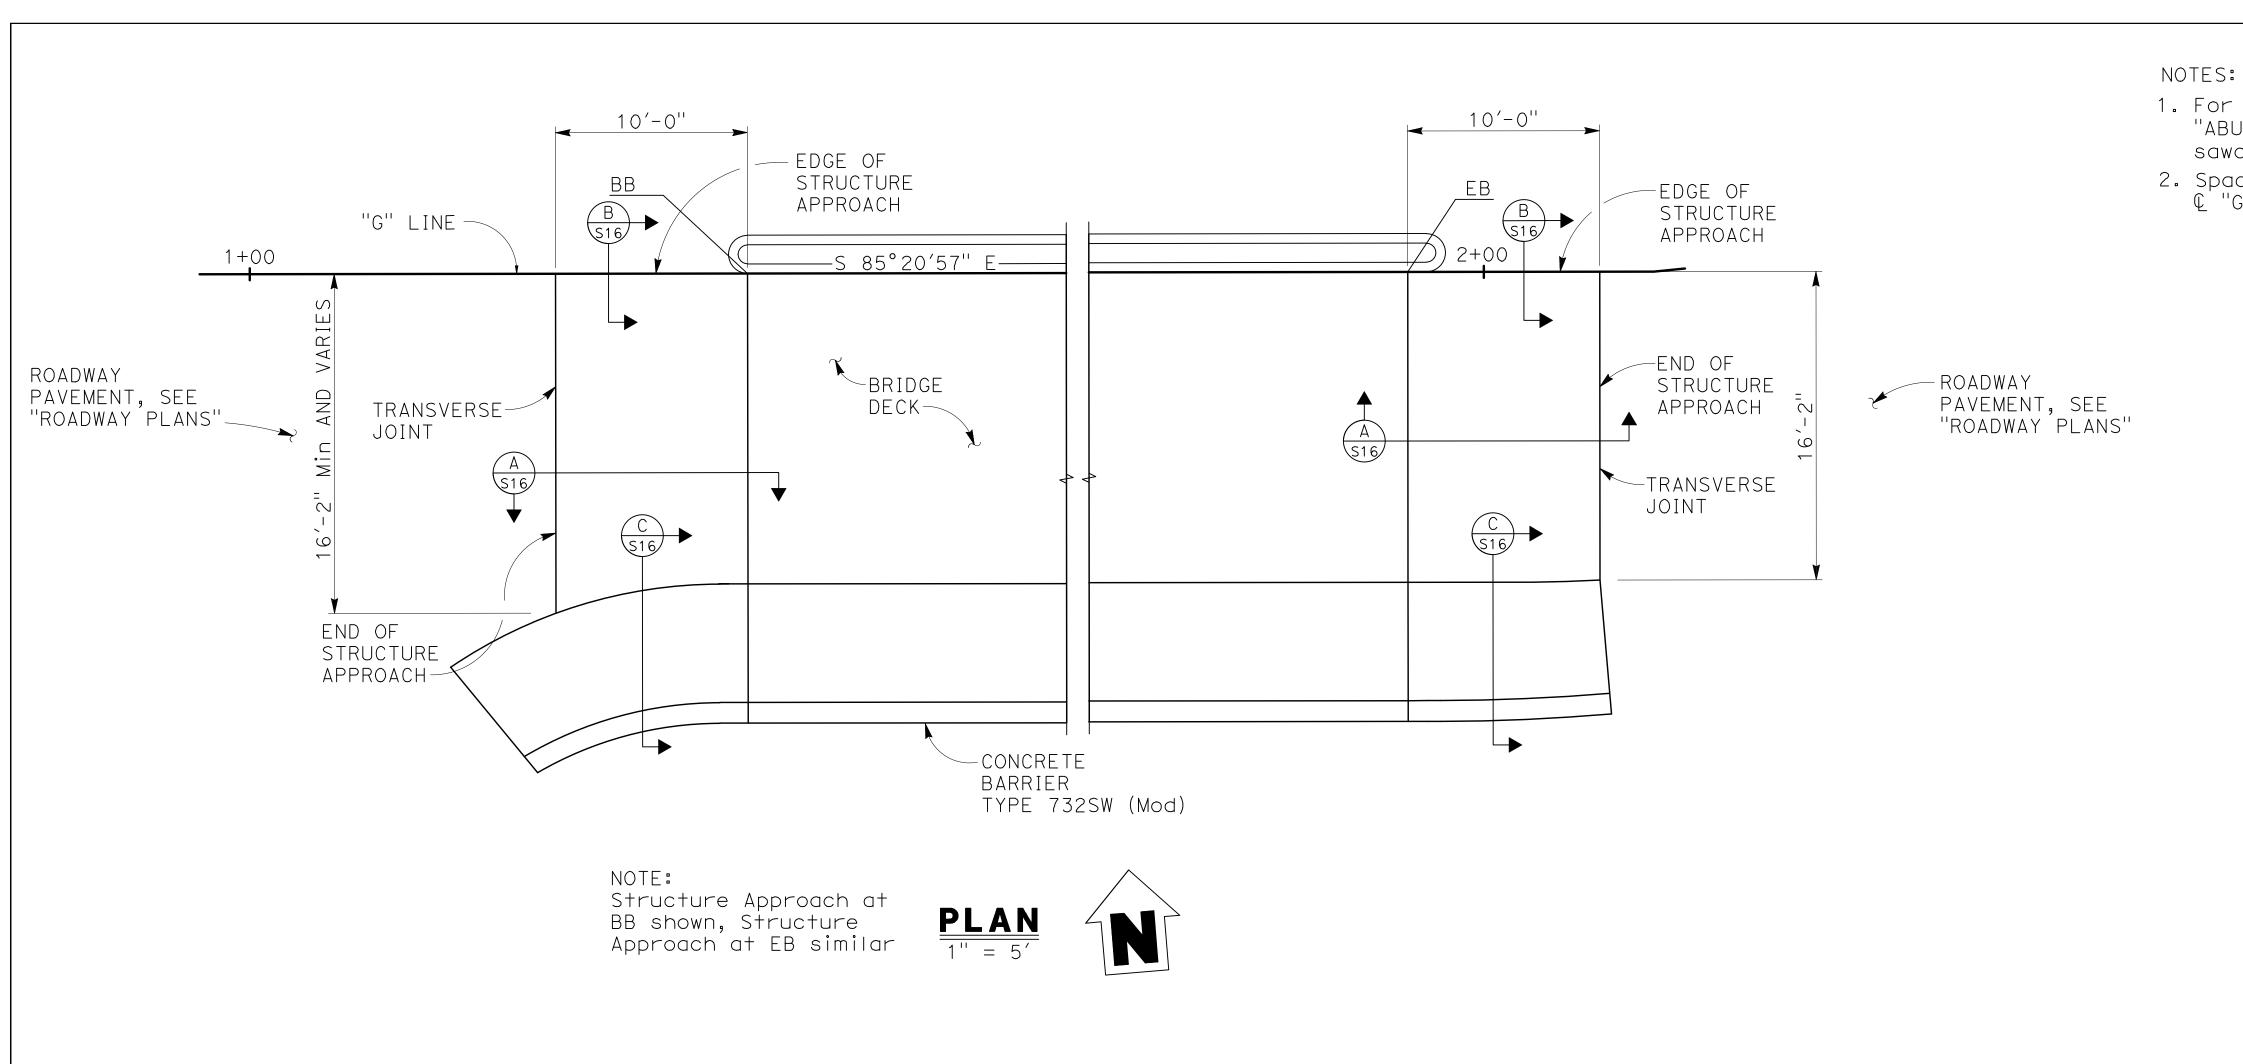


- 1. For joint protection detail and other details not shown, see "ABUTMENT DETAILS No. 1" sheet. Adjust reinforcement to clear sawcut for sealed joint.
- 2. Spacing of transverse reinforcement is measured along & "G" line.

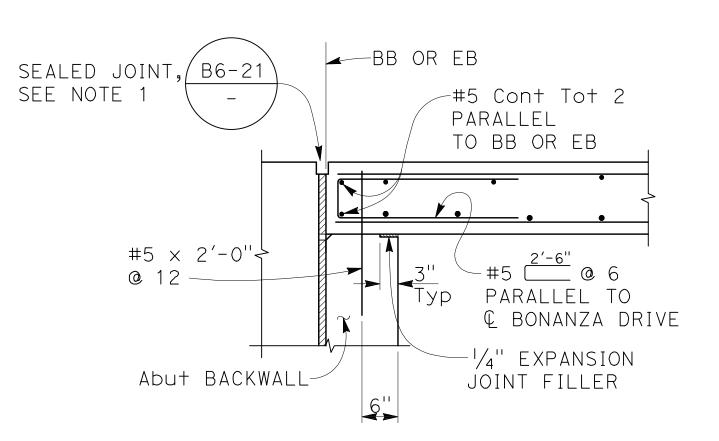



# **ABUTMENT TIE DETAILS** 3/4" = 1'-0"

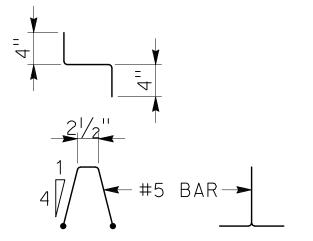

# BAR CHAIR DETAIL 1'' = 1'-0''

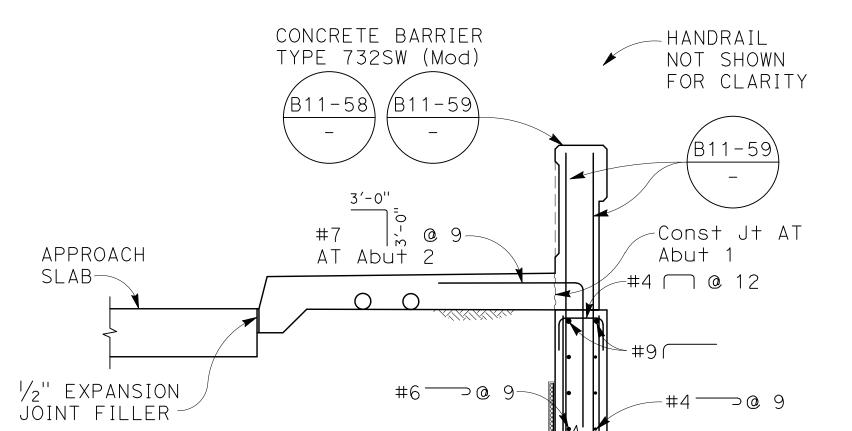

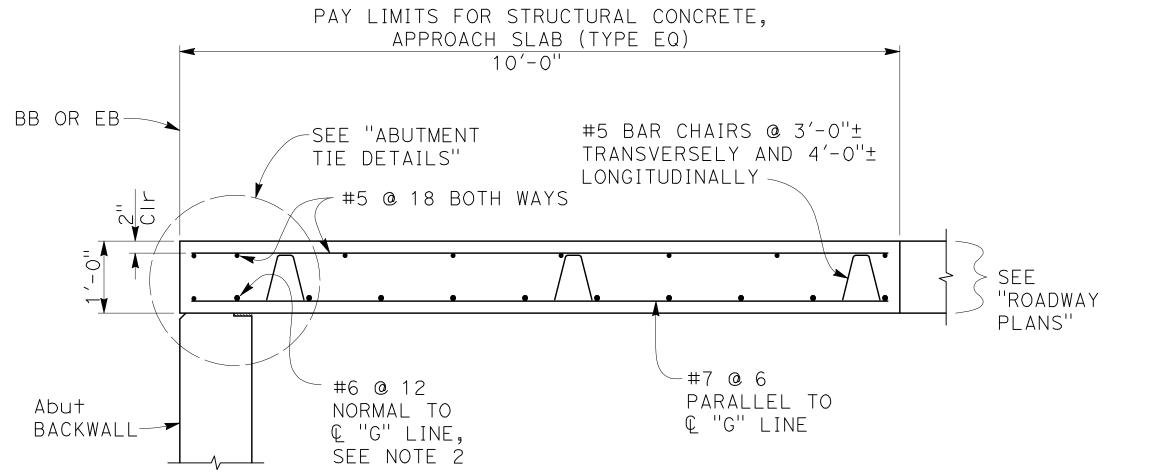

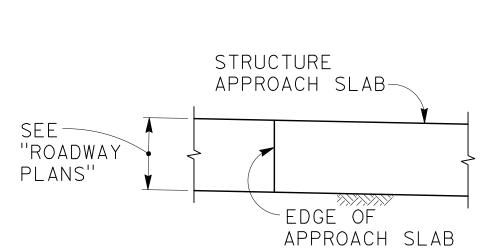



**SECTION** B 3/4" = 1'-0" \$16

# **SECTION** (A) 3/4" = 1'-0" (S16) NOTE: THE CONTRACTOR MUST VERIFY ALL

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Approved (City Engineer)		Submitted (Project Engineer)	CV
Date		Date	12/15/23
		This Drawing sha	Il not be used

Client	CITY OF NOVATO
Project	GRANT AVENUE BRIDGE REHABILITATION
Title	STRUCTURE APPROACH SLAB TYPE EQ (10)

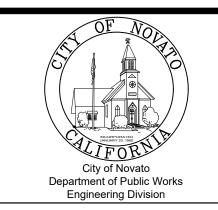
Contract No. **09-003** Scale Scale for Construction unless Signed and Sealed For Construction

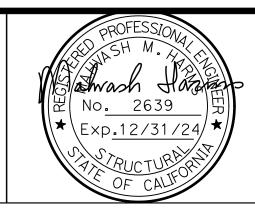This Brawing Shail flot be used to be u

SECTION C

 $1/2'' = 1'-0'' \sqrt{516}$ 

Sht 45 of 47

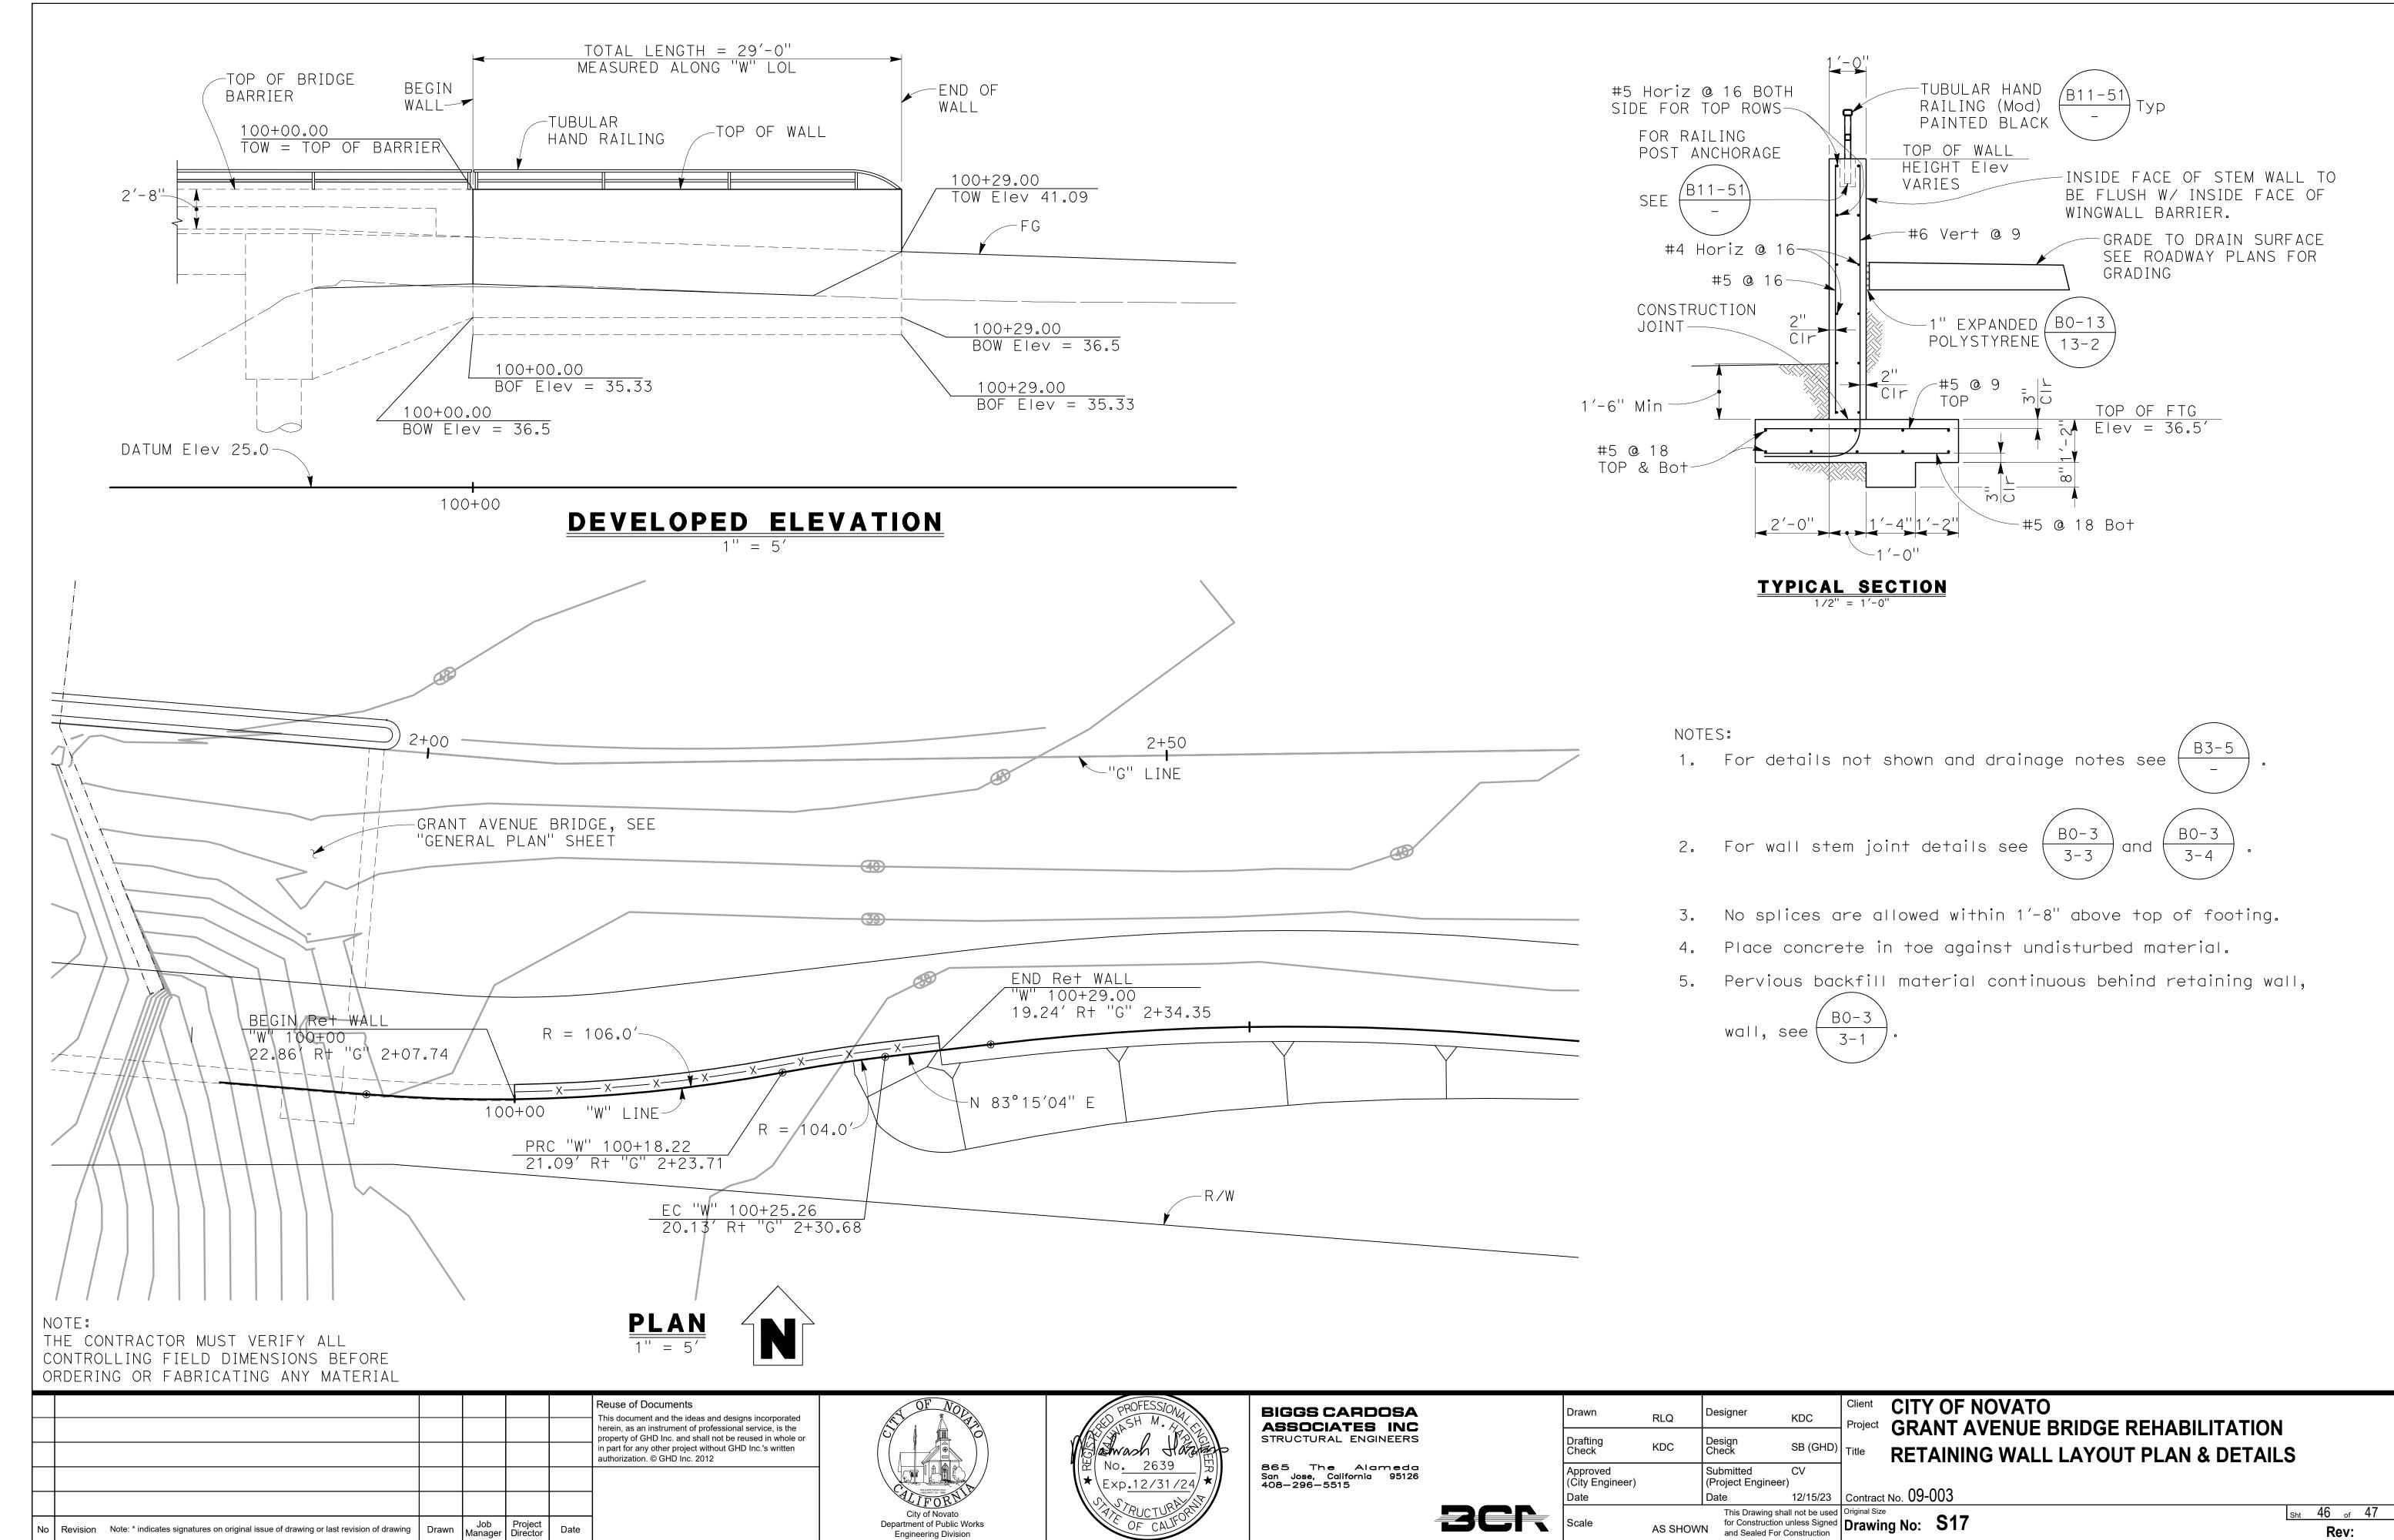

Plot Date: 21 December 2023 - 8:24 PM Plotted by: Jake Delgado

Cad File No: W:\2016\2016042\2016042S17.dwg

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